MUNICIPALITY OF ANCHORAGE PERFORMING ARTS CENTER ELEVATOR MODERNIZATION

621 W 6TH AVE ANCHORAGE, ALASKA 99501

OWNER

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ELEVATOR CONSULTANT

LERCH BATES ASSOCIATES

MECHANICAL & ELECTRICAL ENGINEERS

19515 NORTH CREEK PARKWAY, SUITE 304 **BOTHELL, WASHINGTON 98011**


T. 425.205.2205

RSA ENGINEERING, INC.

670 WEST FIREWEED LN, SUITE 200 ANCHORAGE, ALASKA 99503

T. 907.276.0521 F. 907.856.0563

VICINITY MAP

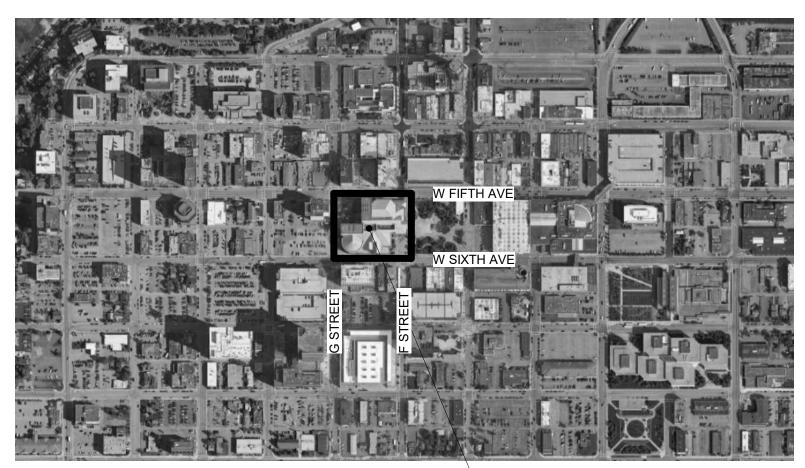



INDEX TO DRAWINGS

GENERAL

PROJECT DATA, INDEX TO DRAWINGS, ABBREVIATIONS AND SYMBOLS

ARCHITECTURAL

REFERENCE PLAN

ENLARGED DEMOLITION PLANS ENLARGED DEMOLITION PLANS ENLARGED DEMOLITION PLANS ENLARGED FLOOR PLANS ENLARGED FLOOR PLANS ENLARGED FLOOR PLANS

ELEVATOR SECTION

PHOTOS PHOTOS

MECHANICAL

LEGEND, SCHEDULES, AND ABBREVIATIONS

DEMOLITION PLANS DEMOLITION PLANS REMODEL PLANS M202 REMODEL PLANS **DETAILS**

ELECTRICAL

LEGEND. SCHEDULES AND ABBREVIATIONS **ELECTRICAL SPECIFICATIONS ELECTRICAL DETAILS ELEVATOR DEMOLITION PLANS ELEVATOR DEMOLITION PLANS ELEVATOR DEMOLITION PLANS ELEVATOR REMODEL PLAN**

ELEVATOR REMODEL PLAN

ABBREVIATIONS

and centerline diameter pound or number anchor bolt ACT acoustical tile ADD ADD'L additional ADH adhesive ADJ adjustable **AFF** above finished floor access panel APPROX approximate **BLDG** building block or blocking bottom of CEM

CER CLG CO CLO CMU COL CONST CONT CPT CT DEMO DET DIAM DIM DISP DN DS DWG

ELEC

EPS

ceramic ceiling carbon monoxide concrete masonry unit construction continuous ceramic tile demolition drinking fountain dimension drawing

electrical

expanded polystyrene

equal **EQUIP** equipment exterior **EXIST** existing EXST'G fire alarm fiber cement board floor clean out **FCTY** factory finish floor drain foundation fire extinguisher fire extinguisher cabinet FHC fire hose cabinet floor FO face of FOC face of concrete FOF face of finish FOS face of stud FRP fiberglass reinf. panel

furnace

FURN

field verify GB grab bar **GLBM GWB** hardware HORIZ horizontal HT INSU INT interior LAV lavatory

MFD gauge or gage galvanized MIN glass or glazing MR glu-lam beam MTD gypsum wall board NIC hollow metal NO heating, ventilating, and air conditioning OC hot water heater OD OSB PNT mechanical

ABBREVIATIONS INDICATED MAY NOT ALL BE USED IN THESE CONSTRUCTION DOCUMENTS. SEE MECHANICAL & ELECTRICAL FOR ABBREVIATIONS SPECIFIC TO THOSE DISCIPLINES. manufactured PTD manufacturer manhole minimum, minute miscellaneous mop rack mounted **REQ** material REQM'7 not in contract RO number R&S nominal SA-VF SD on center overflow drain owner furnished contractor installecsim owner furnished owner installed oriented strand board plastic laminate PLYWD plywood **STOR**

pressure treated paper towel dispenser paper towel dispenser / receptacle paper towel receptacle quarry tile roof drain required requirements rough opening rod and shelf self-adhered vapor retarder soap dispenser section shower similar structural insulated panel sanitary napkin dispenser sanitary napkin receptacle specification storage

STRL structural **STRUCT** structural suspended S.V. sheet vinyl T&G tongue and groove trash chute T.O. top of toilet paper dispenser **TPD** TYP typical unless noted otherwise **VERT** VR VTR

unit heater varies vinyl composition tile vertical vapor retarder vent through roof washer with wood

water heater

wainscot

water resistant

SYMBOLS

(100) $\langle 1 \rangle$

DOOR NUMBER


KEYNOTE

ROOM

1

ROOM NAME & NUMBER

WORK POINT, CONTROL POINT OR DATUM POINT

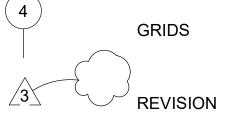

0 $\mathbf{\Sigma}$ OR R

DATE: 3/9/22

ФШ

DRAWN: HLC CHECKED: DJD


PROJECT: 1718.60

DRAWING TITLE: PROJECT DATA, INDEX TO DRAWINGS. ABBREVIATIONS AND _SYMBOLS_

REVISIONS:

SHEET NO:

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PERFORMING ARTS CENTE ELEVATOR MODERNIZATIO

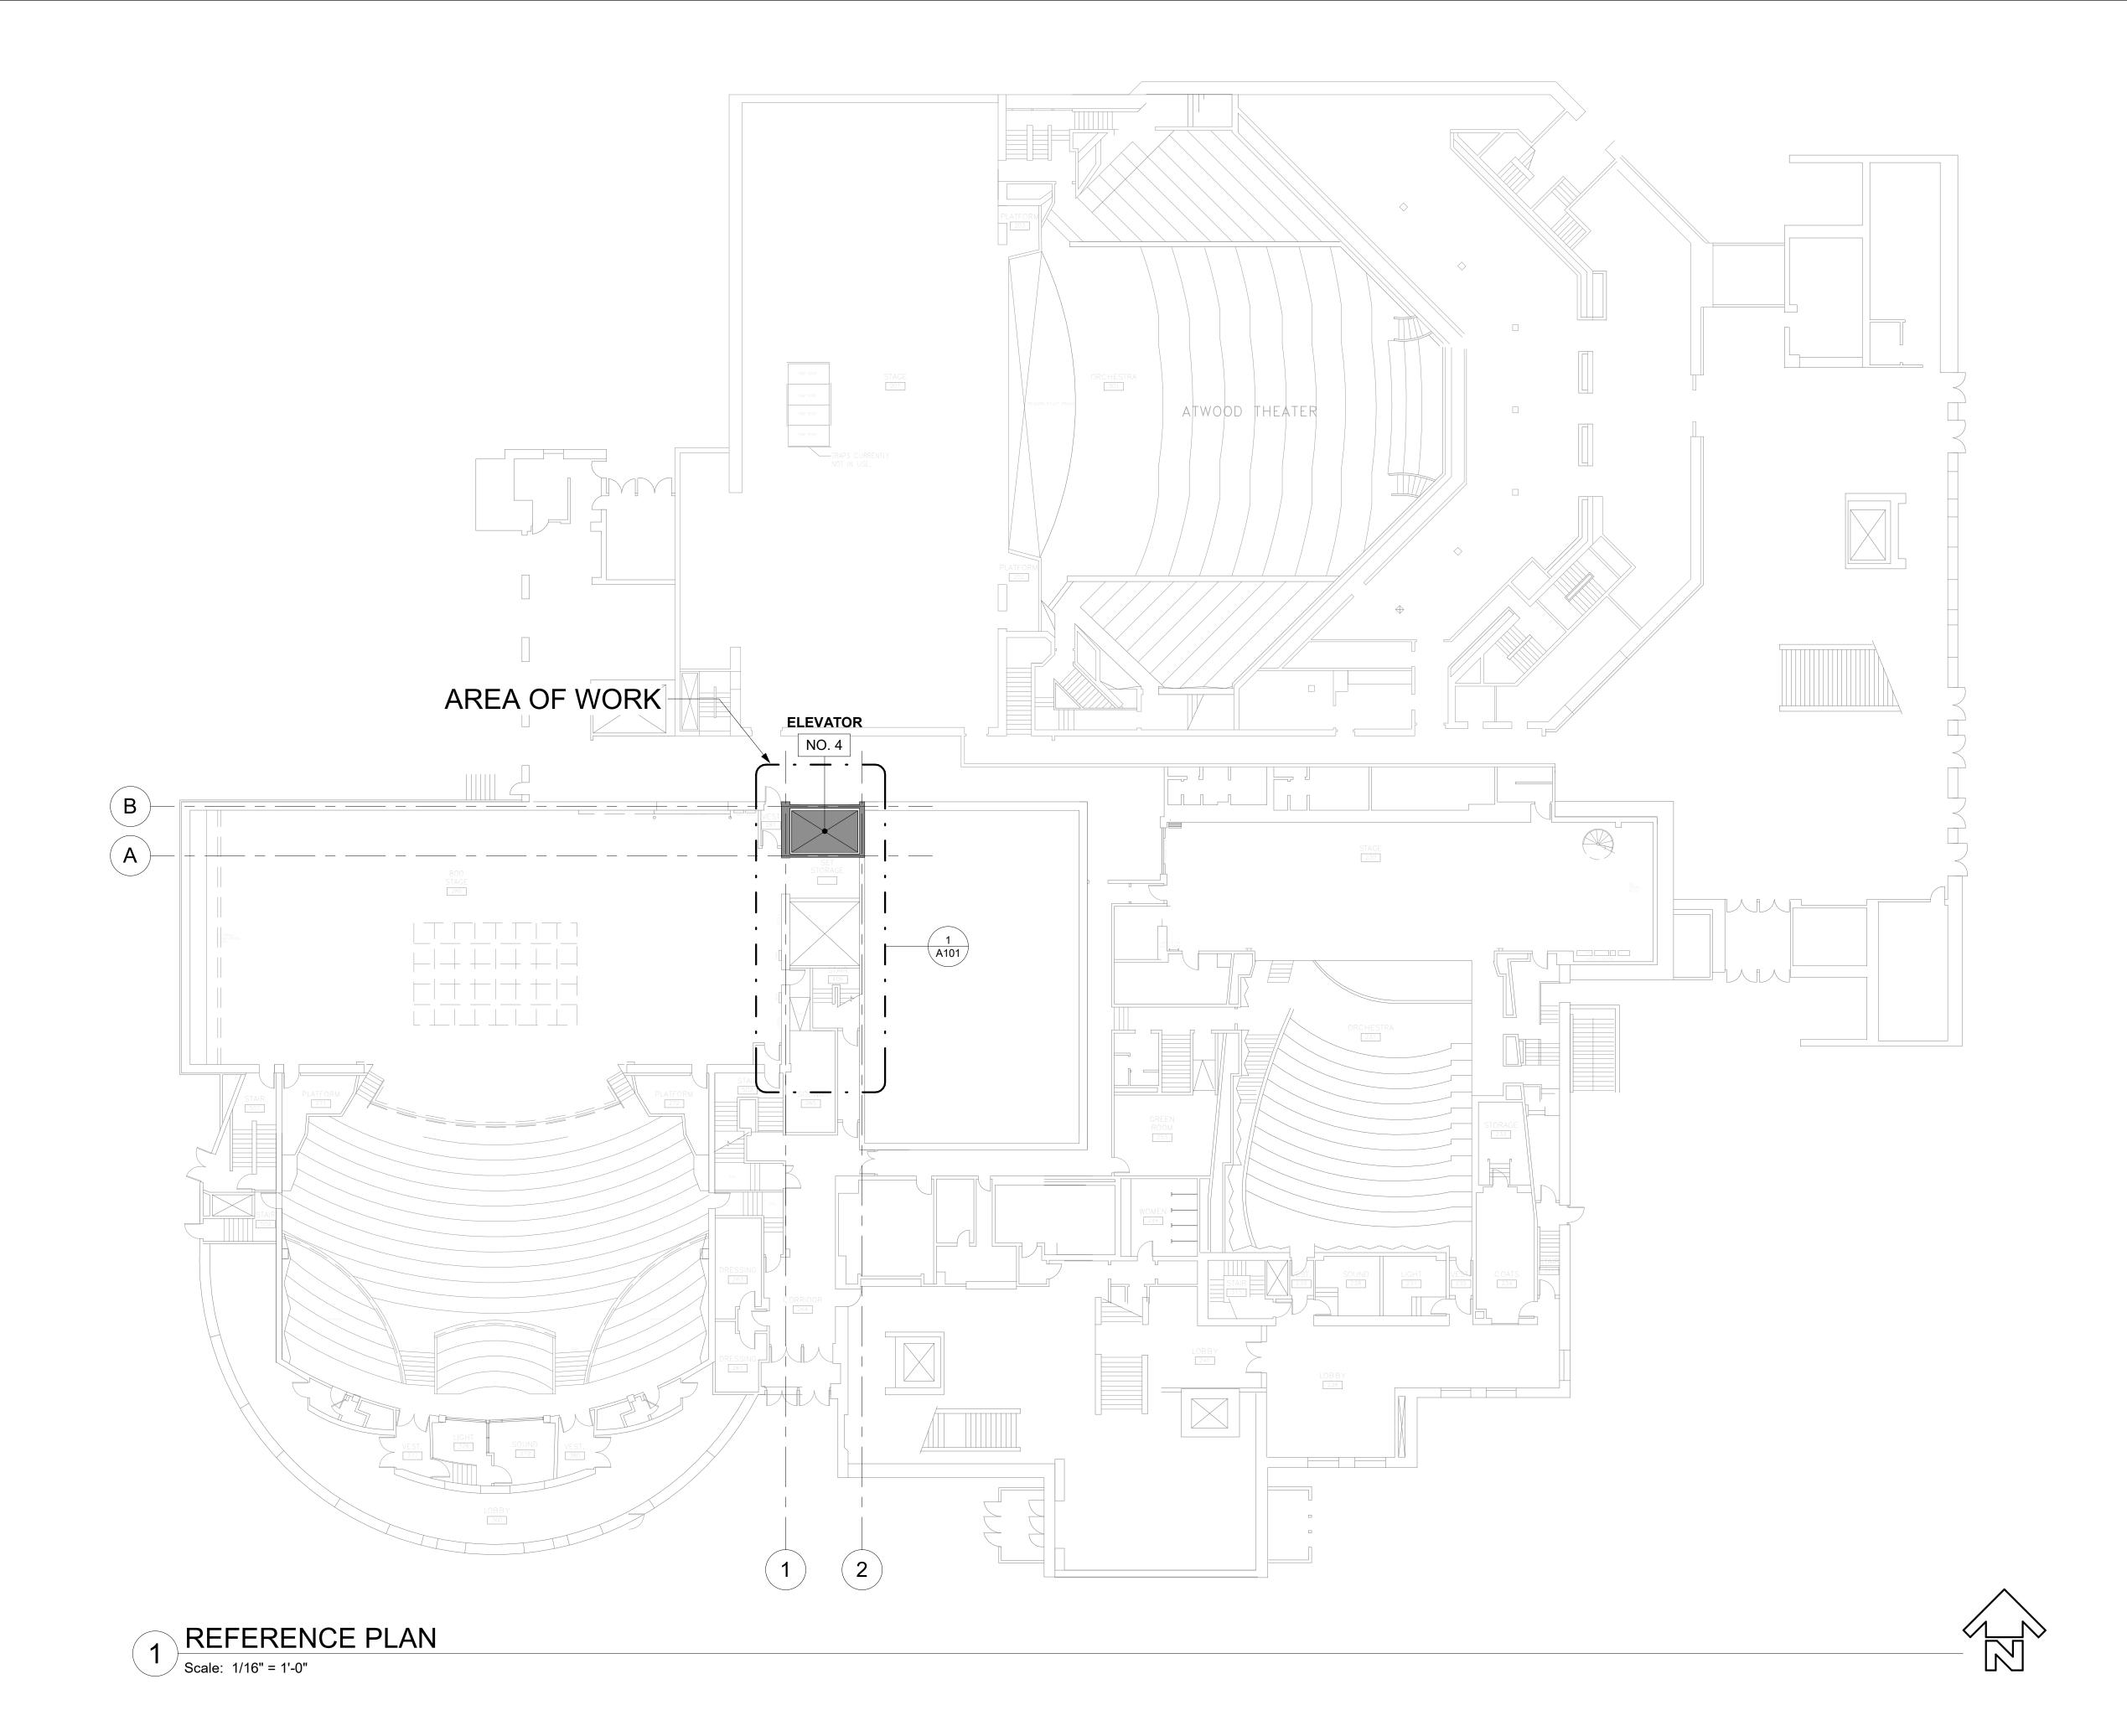DATE: 3/9/22

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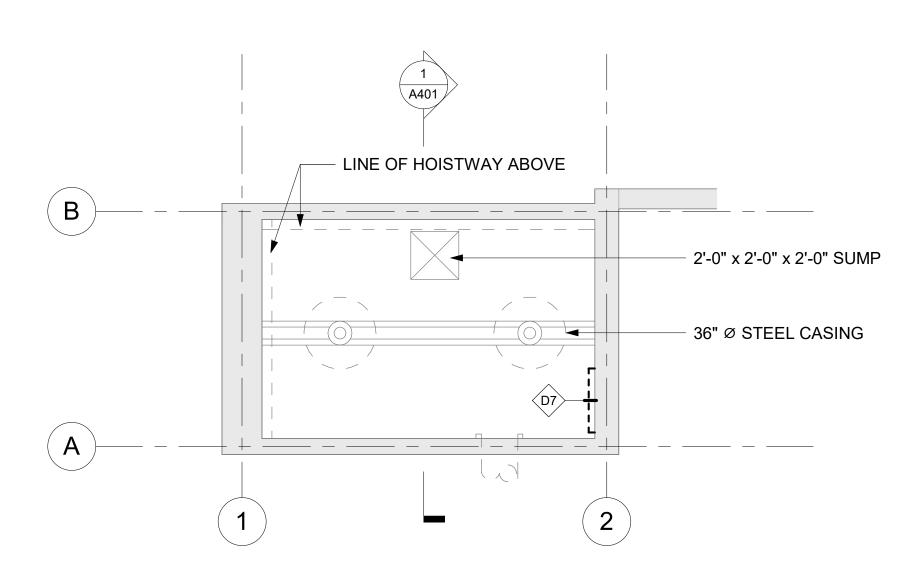
PROJECT: 1718.60
DRAWING TITLE:

REFERENCE PLAN

REVISIONS:

SHEET NO:

2 ENLARGED LOWER REHERSAL DEMOLITION PLAN [1/A401] Scale: 1/4" = 1'-0"




ENLARGED PIT DEMOLITION PLAN

[1/A100] Scale: 1/4" = 1'-0"

DEMOLITION KEY NOTES D1 REMOVE (E) ELEVATOR GATE D5 REMOVE (E) CAR OPERATING PANEL

REMOVE (E) PIT LADDER D8 REMOVE (E) ELEVATOR MACHINERY

*SEE ELEVATOR SPECIFICATIONS FOR ADDITIONAL WORK

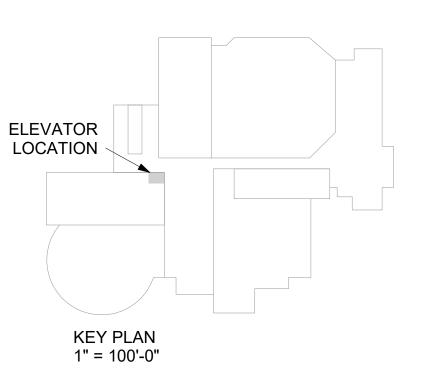



RMING A

DATE: 3/9/22 DRAWN: Author

PERF ELEV

CHECKED: DJD

PROJECT: 1718.60

DRAWING TITLE: ENLARGED DEMOLITION PLANS

REVISIONS:

SHEET NO:

BASEMENT DEMOLITION PLAN

/ [1/A401] Scale: 1/8" = 1'-0"



D1 REMOVE (E) ELEVATOR GATE

D2 REMOVE (E) WALL MOUNTED CALL BUTTON DEVICE


REMOVE (E) DOOR, FRAME, AND HARDWARE

REMOVE (E) HANDRAIL, SALVAGE FOR REINSTALLATION
REMOVE (E) CAR OPERATING PANEL

D6 REMOVE (E) CAR AND HOIST WAY DOOR CONTROLLER

D8 REMOVE (E) ELEVATOR MACHINERY

*SEE ELEVATOR SPECIFICATIONS FOR ADDITIONAL WORK

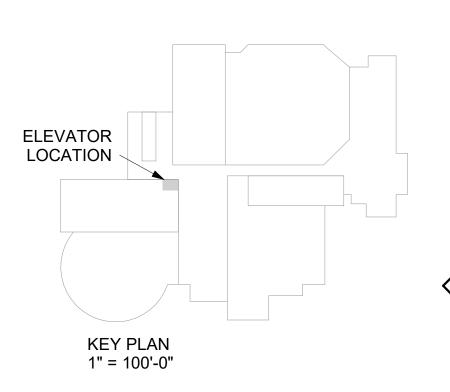



PERFORMING ARTS CENTER ELEVATOR MODERNIZATION 621 W 6TH AVE ANCHORAGE, ALASKA 99501

DATE: 3/9/22


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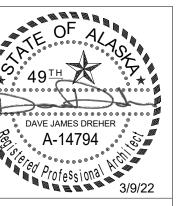
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DRAWING TITLE:
ENLARGED
DEMOLITION PLANS

REVISIONS:

SHEET NO:




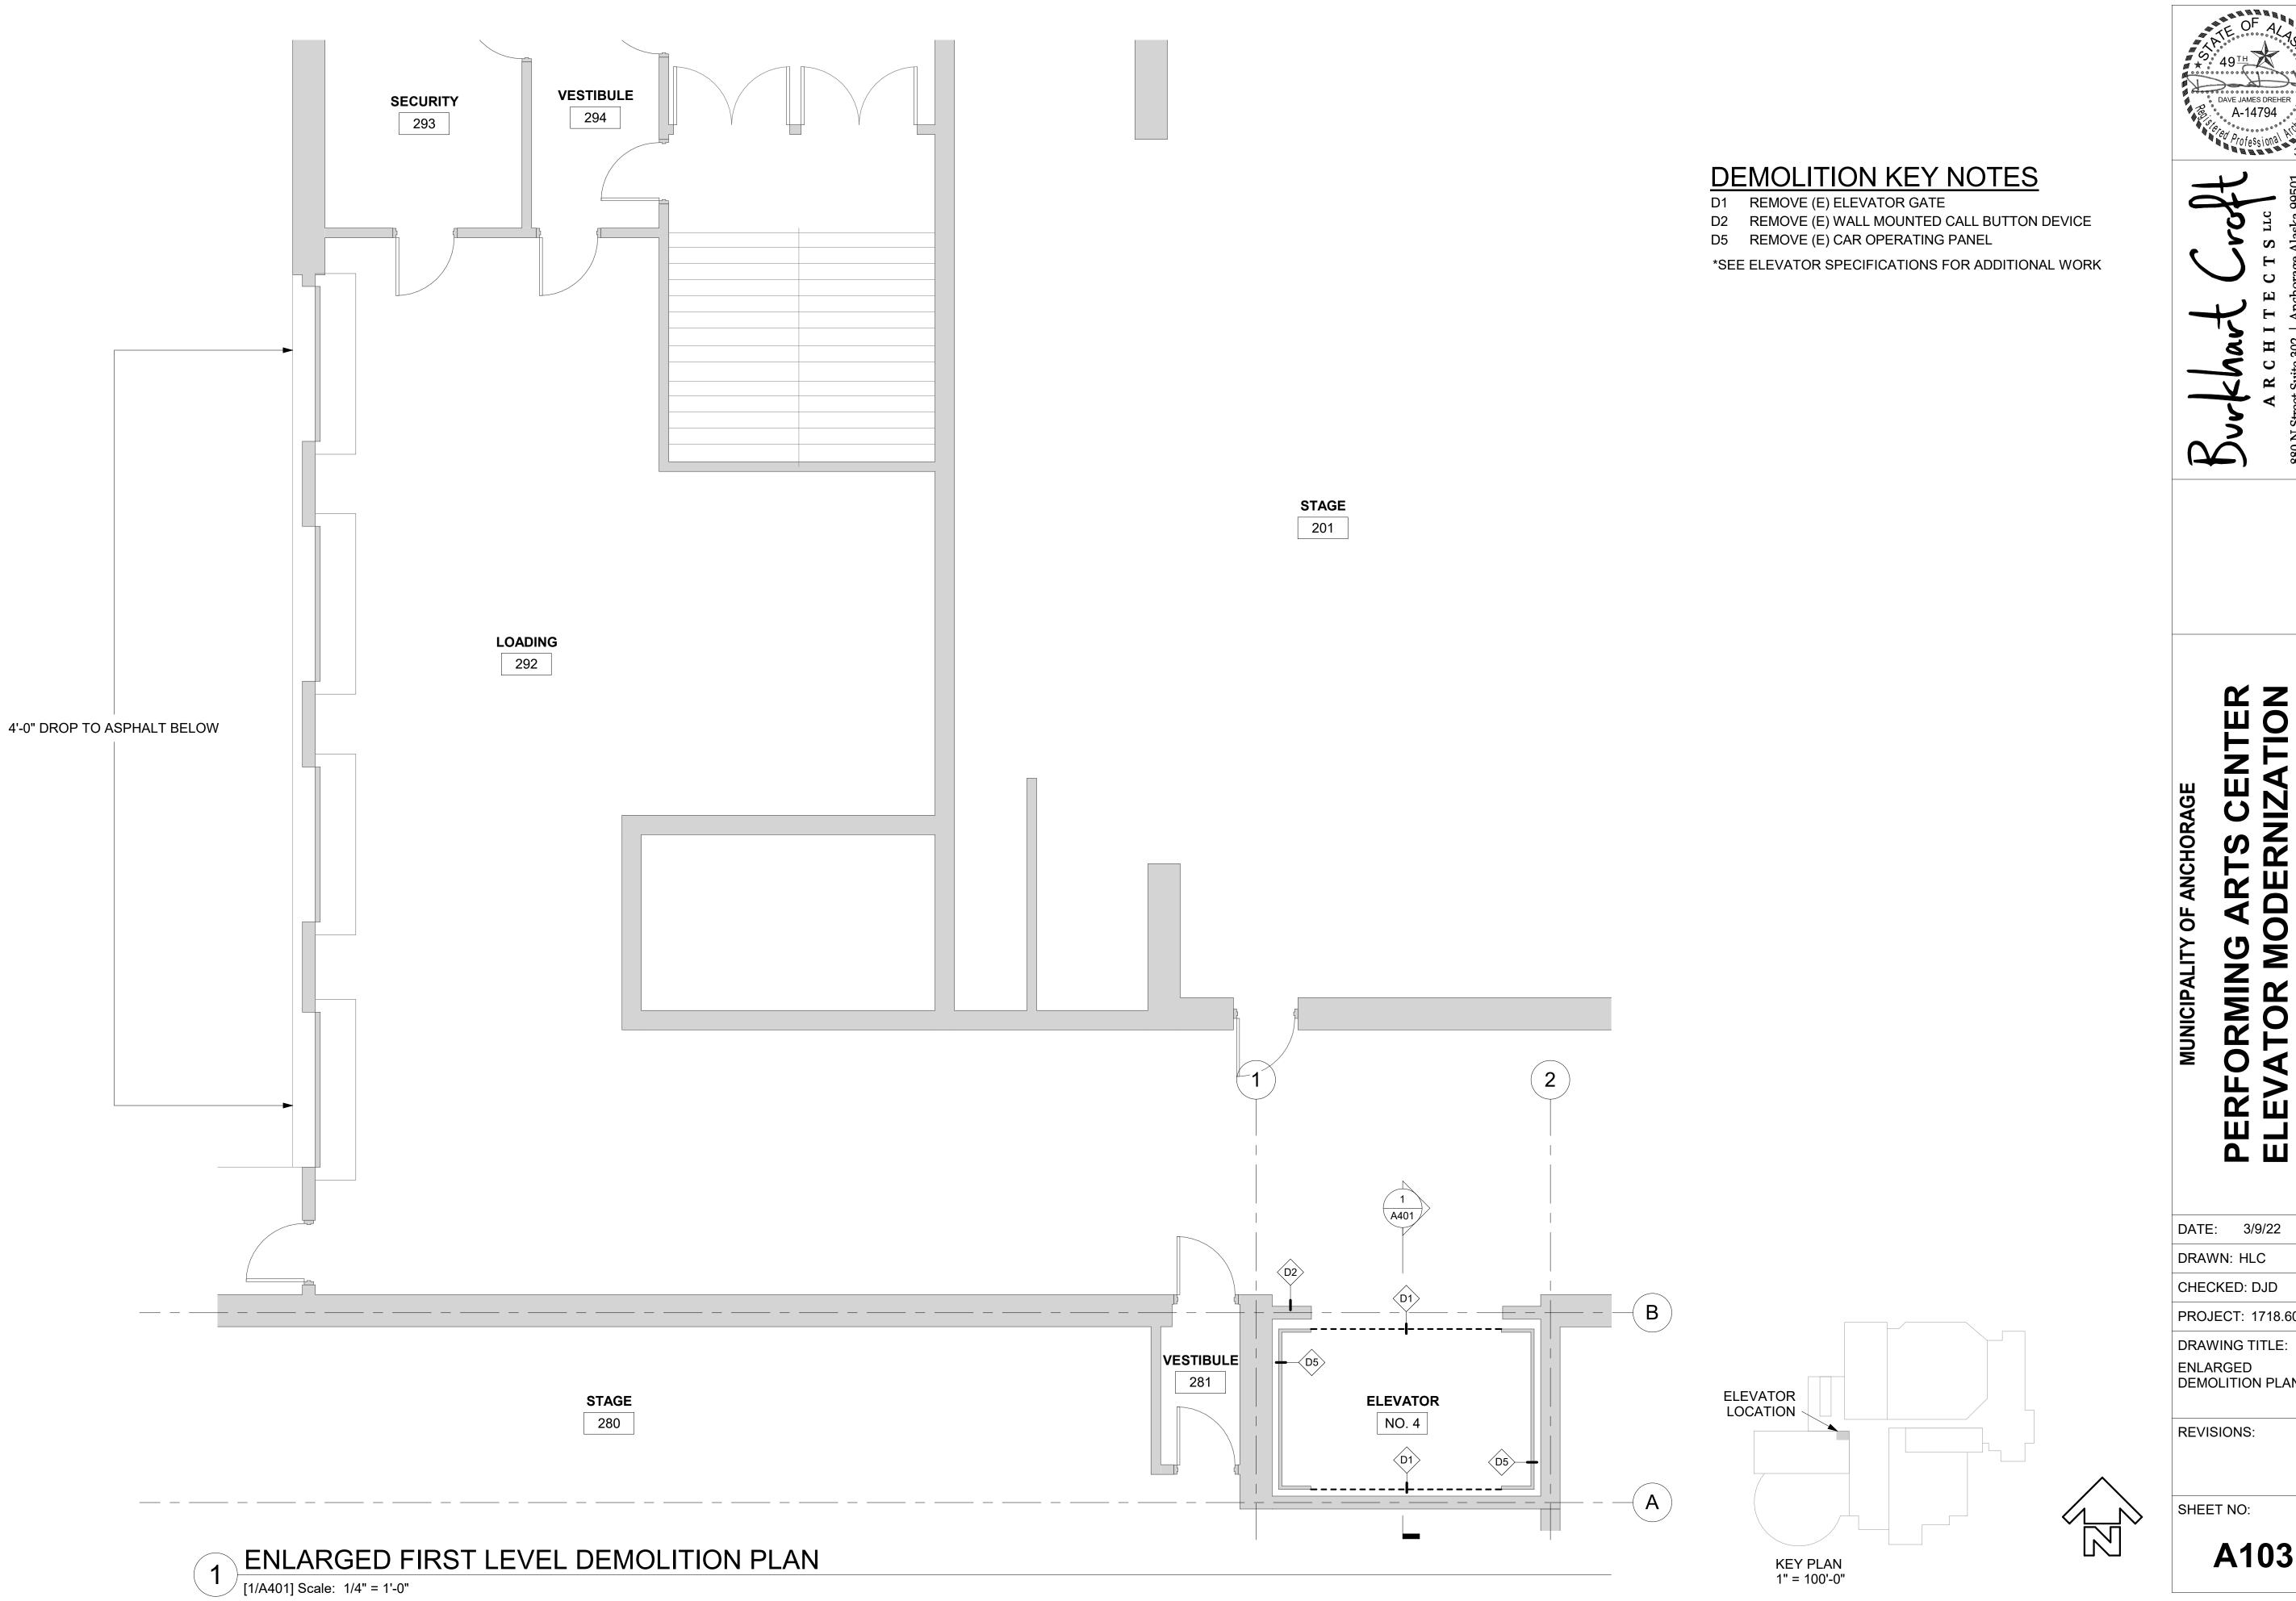


DATE: 3/9/22

PROJECT: 1718.60

DRAWING TITLE: ENLARGED DEMOLITION PLANS

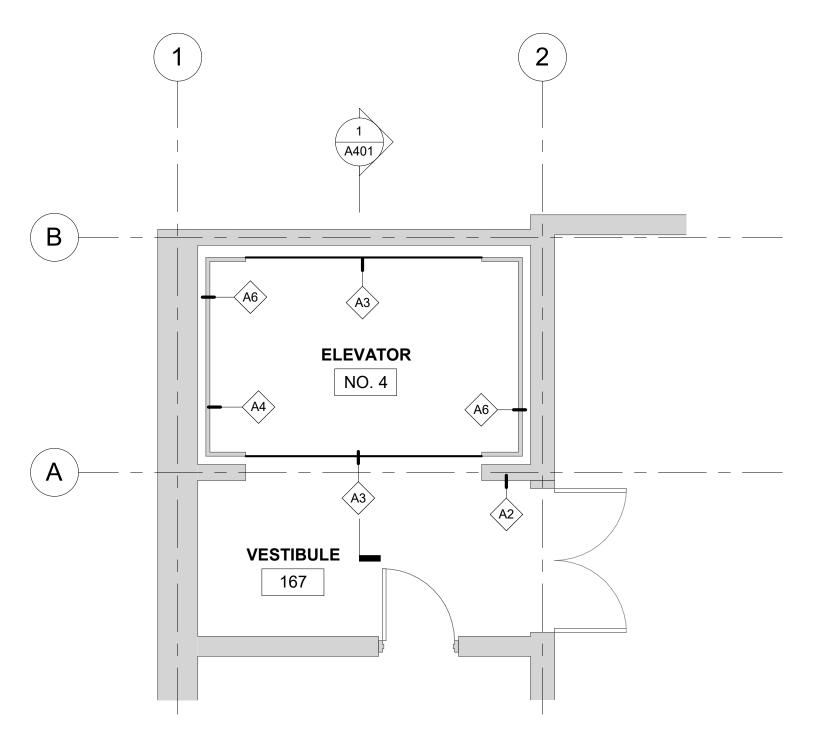

2 ENLARGED LOWER REHERSAL PLAN [1/A401] Scale: 1/4" = 1'-0"

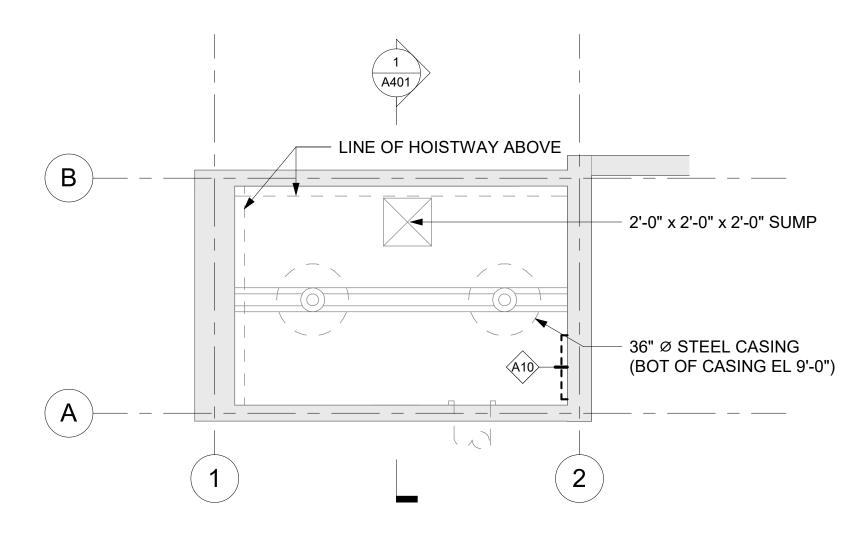

1 ENLARGED PIT PLAN
Scale: 1/4" = 1'-0"



ARCHITECTURAL KEY NOTES


(N) WALL MOUNTED CALL BUTTON DEVICE. PATCH AND PAINT WALL AS NEEDED FOR FINISHED APPEARANCE

A3 (N) ELEVATOR GATE

(E) ELEVATOR CAB TO REMAIN A6 (N) CAR OPERATING PANEL

A10 (N) PIT LADDER

*SEE ELEVATOR SPECIFICATIONS FOR ADDITIONAL WORK

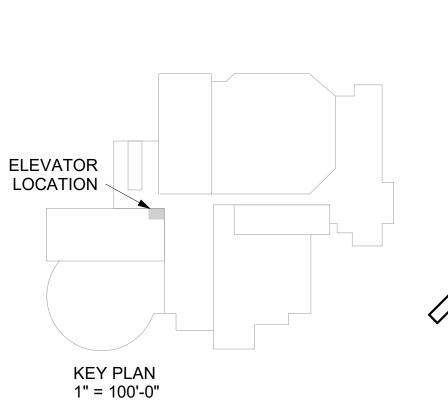



RMING A

DATE: 3/9/22

PERF ELEV

DRAWN: Author


CHECKED: Checker PROJECT: 1718.60

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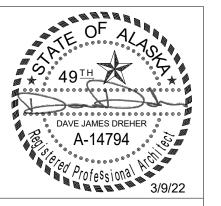
REVISIONS:

SHEET NO:

	DOOR SCHEDULE											
		DOOR						FRAME				
		SIZE								FIRE		
DOOR NO	WIDTH	HEIGHT	THICKNESS	TYPE	MATERIAL	FINISH	TYPE	MATERIAL	FINISH	RATING	REMARKS	
164	3' - 0"	7' - 0"	1 3/4"	F	НМ	PAINT		НМ	PAINT	60		



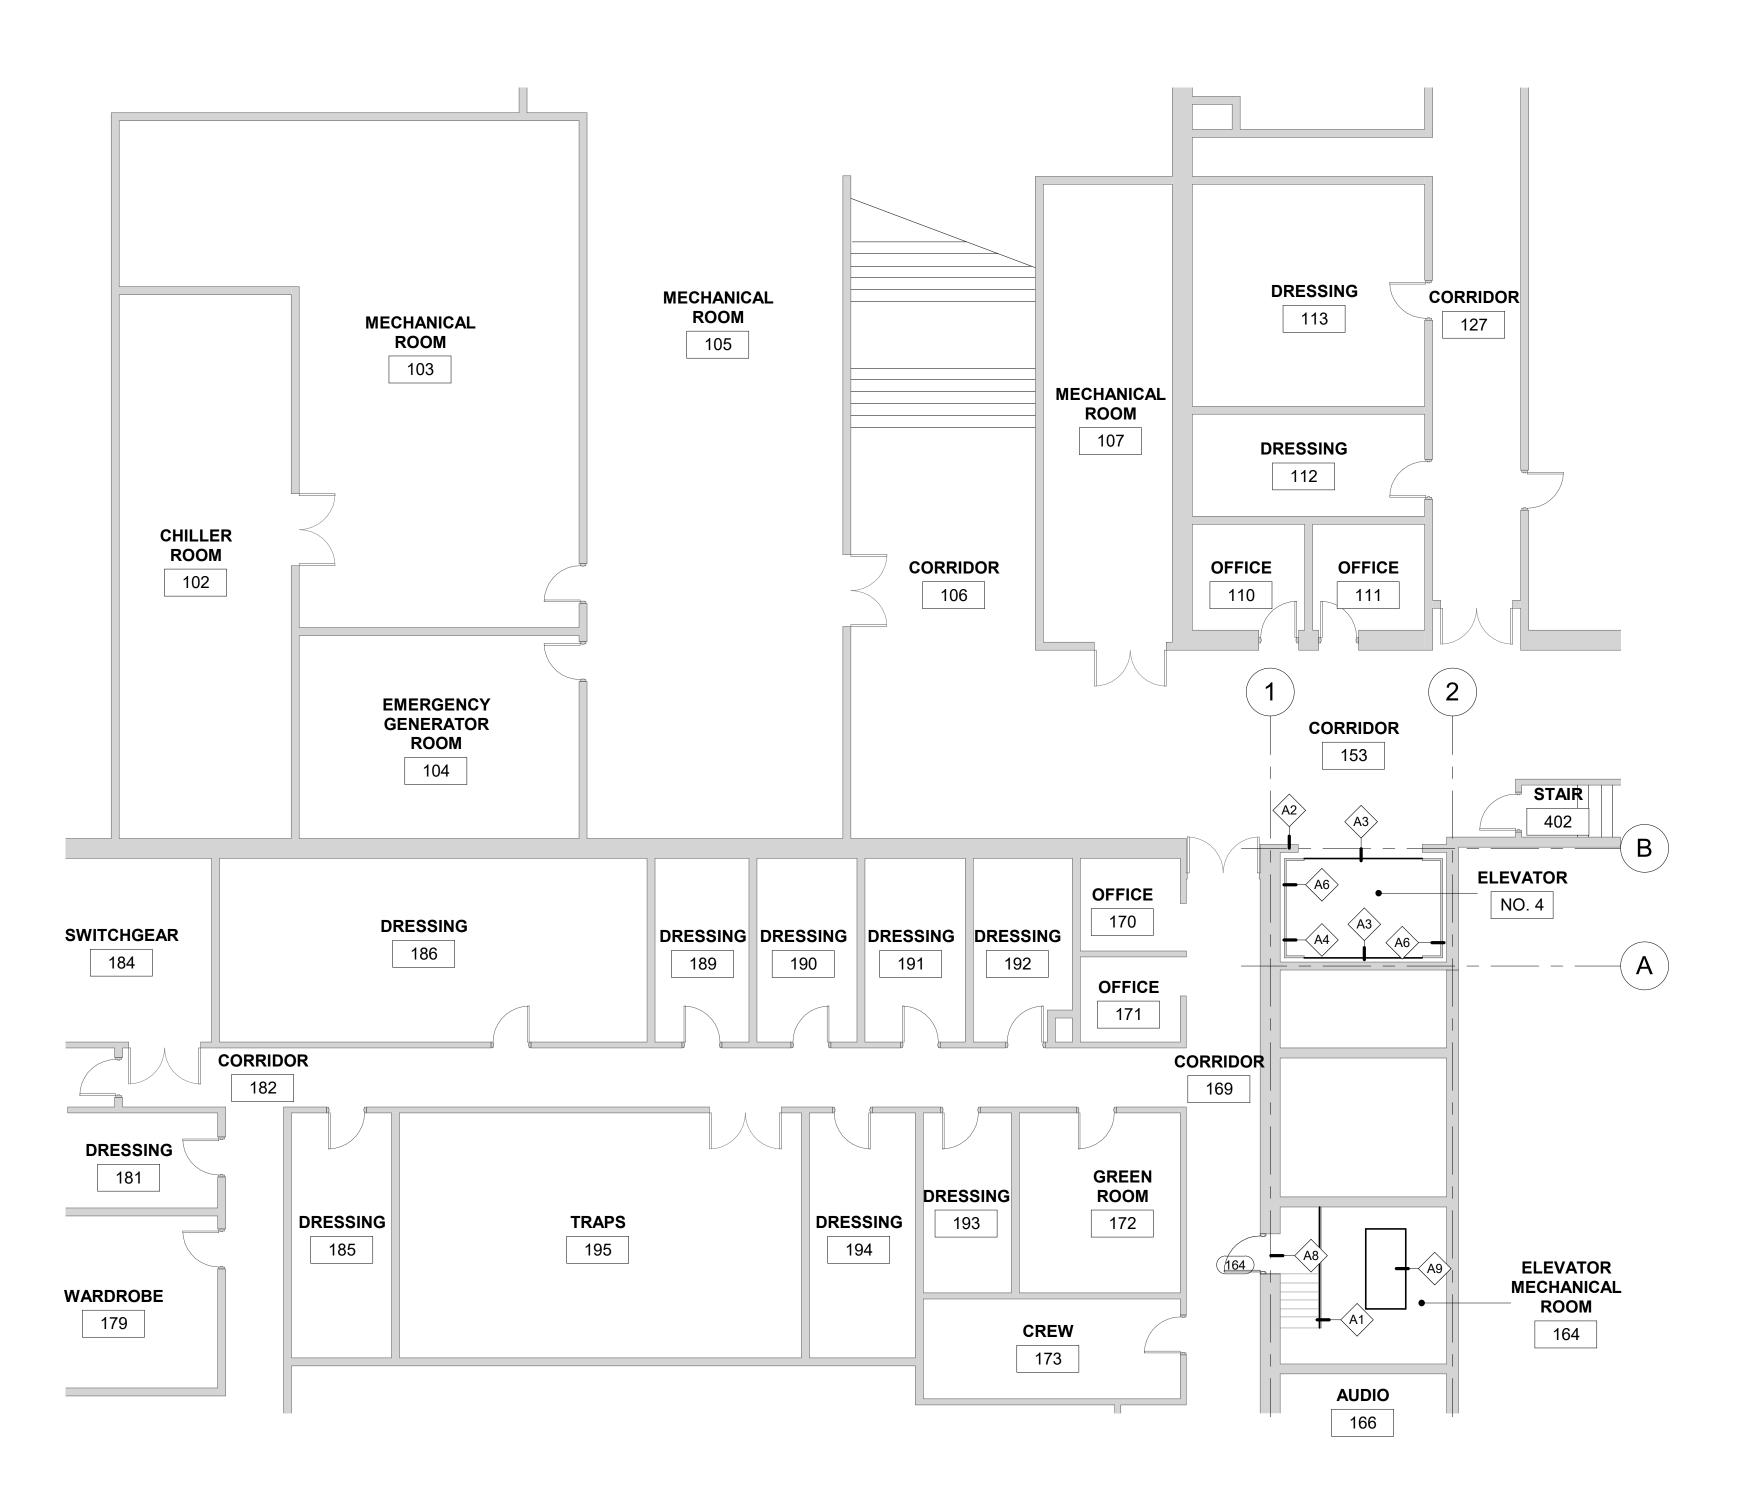




ARCHITECTURAL KEY NOTES


- A1 REINSTALL (E) HANDRAIL REFINISH AND PAINT TO MATCH ADJACENT STL LANDING
- A2 (N) WALL MOUNTED CALL BUTTON DEVICE. PATCH AND PAINT WALL AS NEEDED FOR FINISHED APPEARANCE
- A3 (N) ELEVATOR GATE
- (E) ELEVATOR CAB TO REMAIN
- (N) CAR OPERATING PANEL
- INSTALL (N) DOOR AND FRAME
- LOCATION OF (N) ELEVATOR MACHINERY


*SEE ELEVATOR SPECIFICATIONS FOR ADDITIONAL WORK

DOOR TYPE

FRAME TYPE

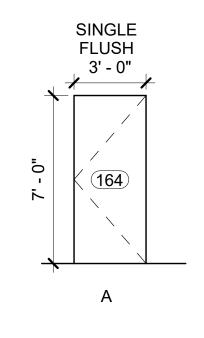

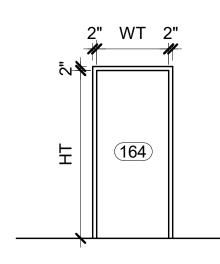

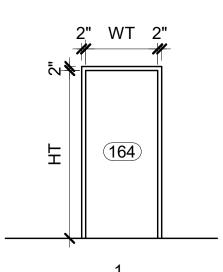

Θ **M** ANCHOR TOR PERF ELEV

DATE: 3/9/22 DRAWN: HLC


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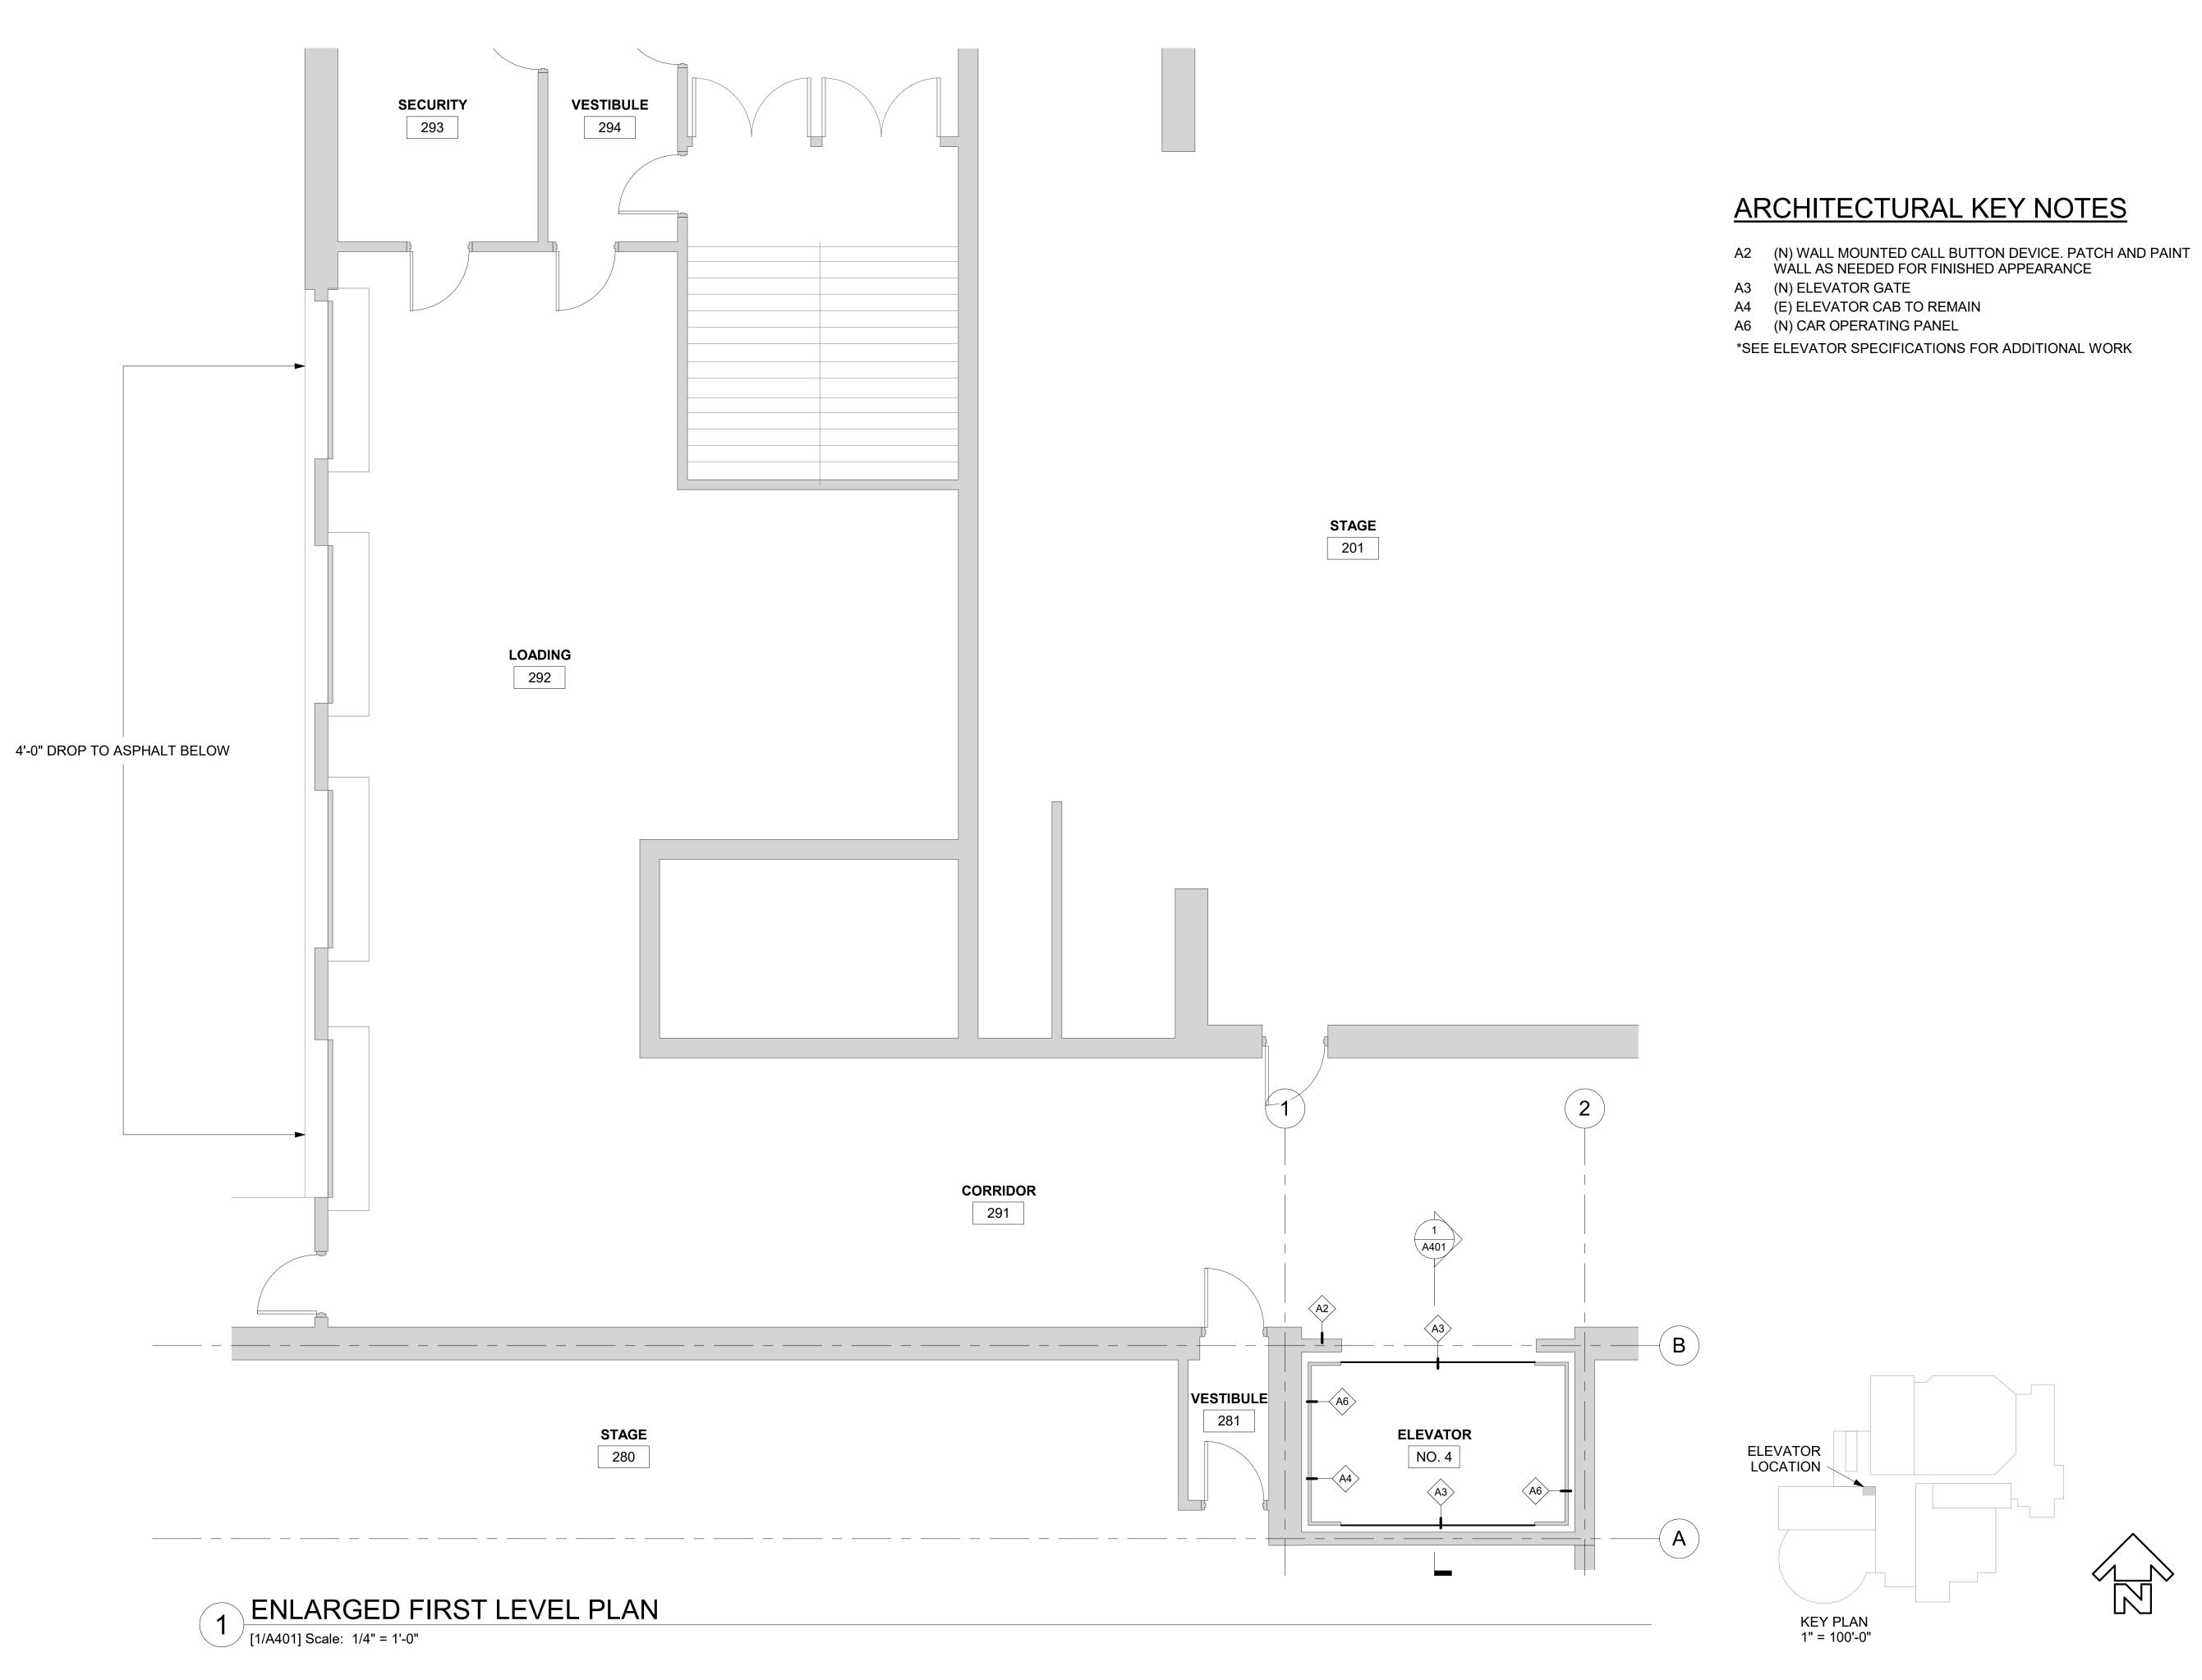
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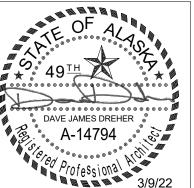
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REVISIONS:

SHEET NO:





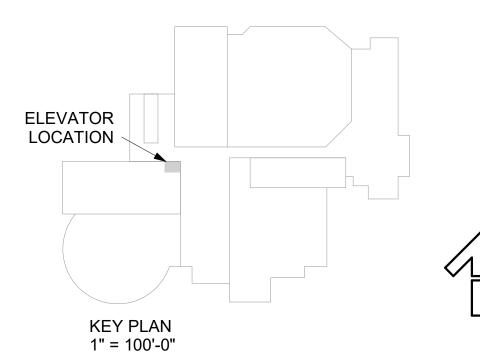

DATE: 3/9/22


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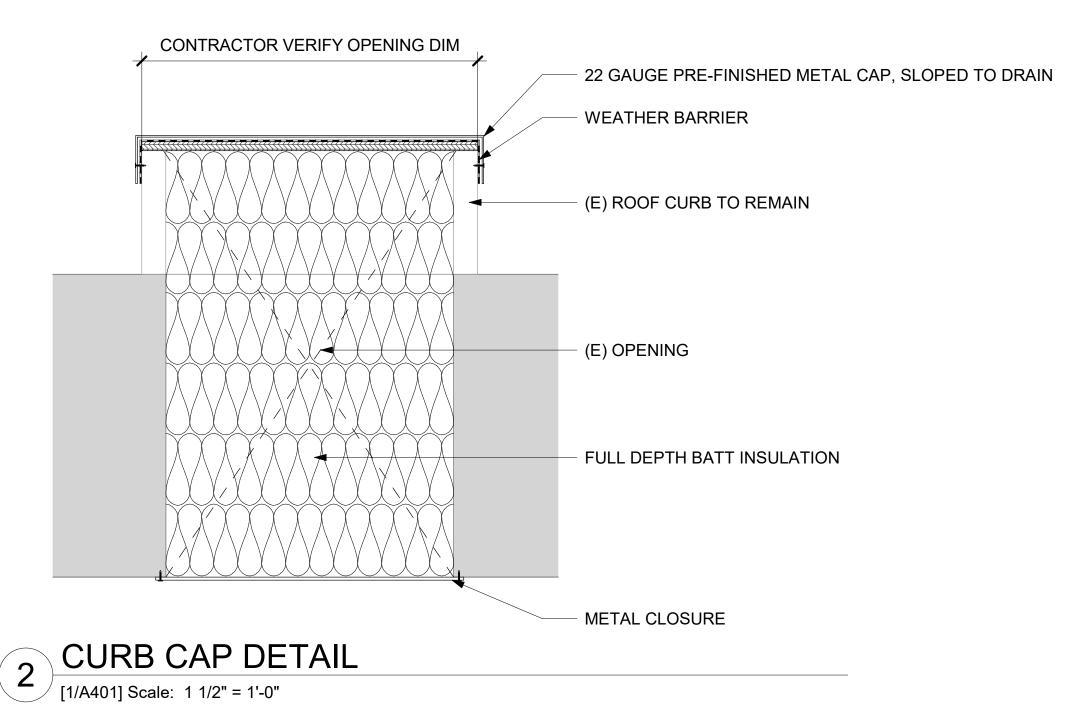
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PROJECT: 1718.60

DRAWING TITLE: ENLARGED FLOOR PLANS

REVISIONS:



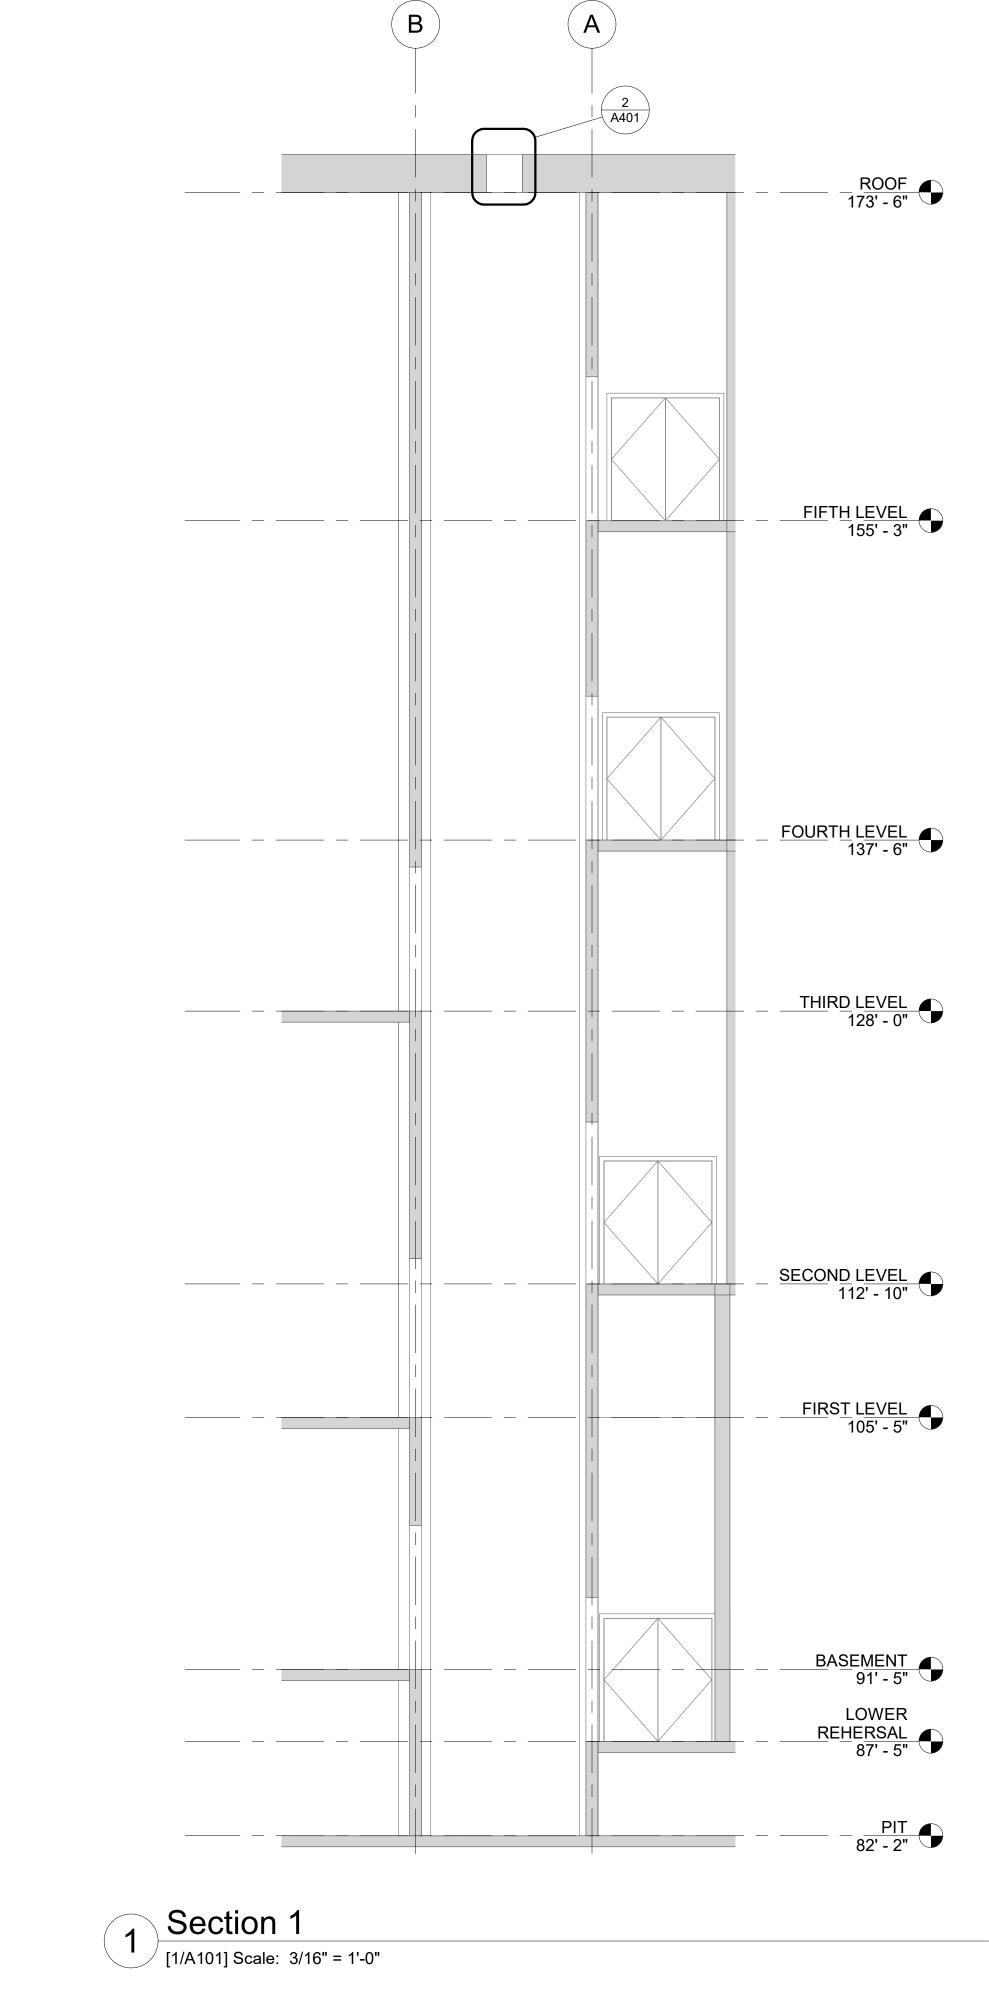

PERFORMING ARTS CENTER
ELEVATOR MODERNIZATION

621 W 6TH AVE ANCHORAGE,

DATE: 3/9/22

DRAWN: HLC
CHECKED: DJD

PROJECT: 1718.60

DRAWING TITLE: ELEVATOR SECTION

REVISIONS:

SHEET NO:

ELEVATOR PIT







ELEVATOR CAR







A R C H I T E C T S LLC

A R C H I T E C T S LLC

A R C H I T E C T S LLC

A R C H I T E C T S LLC

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PERFORMING ARTS
ELEVATOR MODERI
621 W 6TH AVE ANCHORAGE, AL

DATE: 3/9/22

DRAWN: Author
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PROJECT: 1718.60


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REVISIONS:

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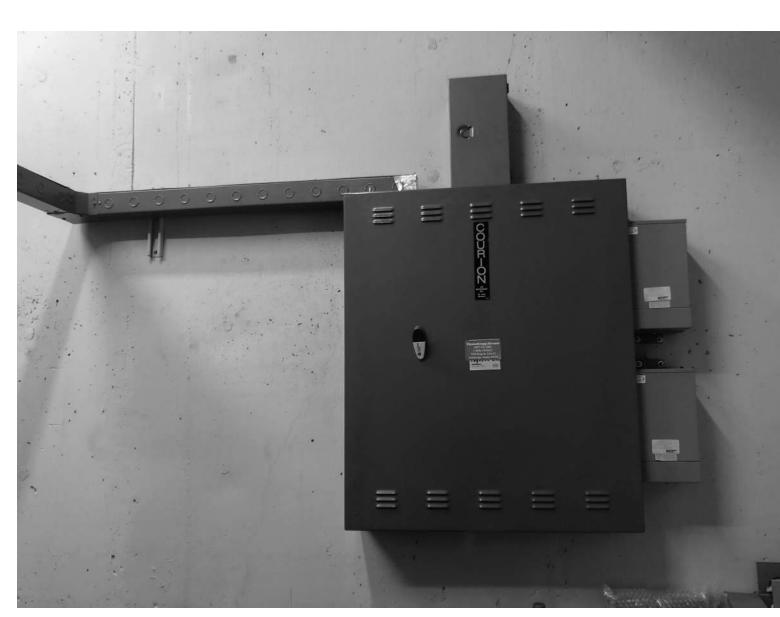
ELEVATOR MECHANICAL ROOM - 164







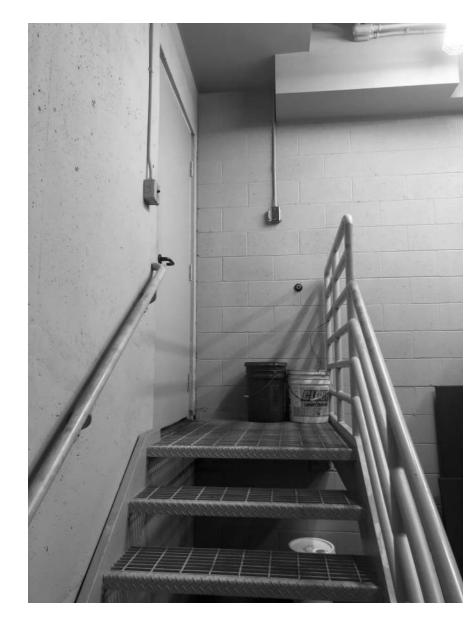



A R C H I T E C T S LLC

880 N Street Suite 302 | Anchorage Alaska 99501

PERFORMING ARTS CE
ELEVATOR MODERNIZA
621 W 6TH AVE ANCHORAGE, ALASKA

DATE: 3/9/22


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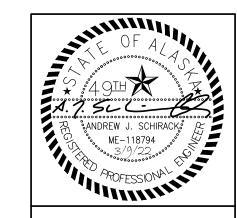
REVISIONS:

SHEET NO:



FAN	SCHEDU	LE								
						ESP		ELECTRICA	AL	
SYMBOL	MANUFACTURER	MODEL	TYPE	SERVICE	CFM	IN W.C.	RPM	WATTS	VOLTS/PH	REMARKS
TF-1	FANTECH	FG-12XL EC	INLINE	ELEVATOR MACHINE ROOM	600	0.5	2150	2150	120/1	PROVIDE WITH UNIT MOUNTED FAN SPEED CONTROLLER.

PUM	IP SCHED	ULE							
				PUMPED		HEAD	ELECTR	ICAL	
SYMBOL	MANUFACTURER	MODEL	FUNCTION	MEDIUM	GPM	FEET	HP	VOLTS/PH	REMARKS
PMP-40	LIBERTY PUMPS	ELV 290	ELEVATOR SUMP PUMP	WATER	50	18	3/4	120/1	AUTOMATIC OPERATION, PROVIDE WITH OILCEPTOR LIBERTY CONTROL PANEL AND REMOTE ALARM. PROVIDE PUMP W/ 6' PLUG CORD.
PMP-33	LIBERTY PUMPS	ELV 290	MECHANICAL RM 103 SUMP PUMP	WATER	50	20	3/4	120/1	AUTOMATIC OPERATION, 25' CORD.

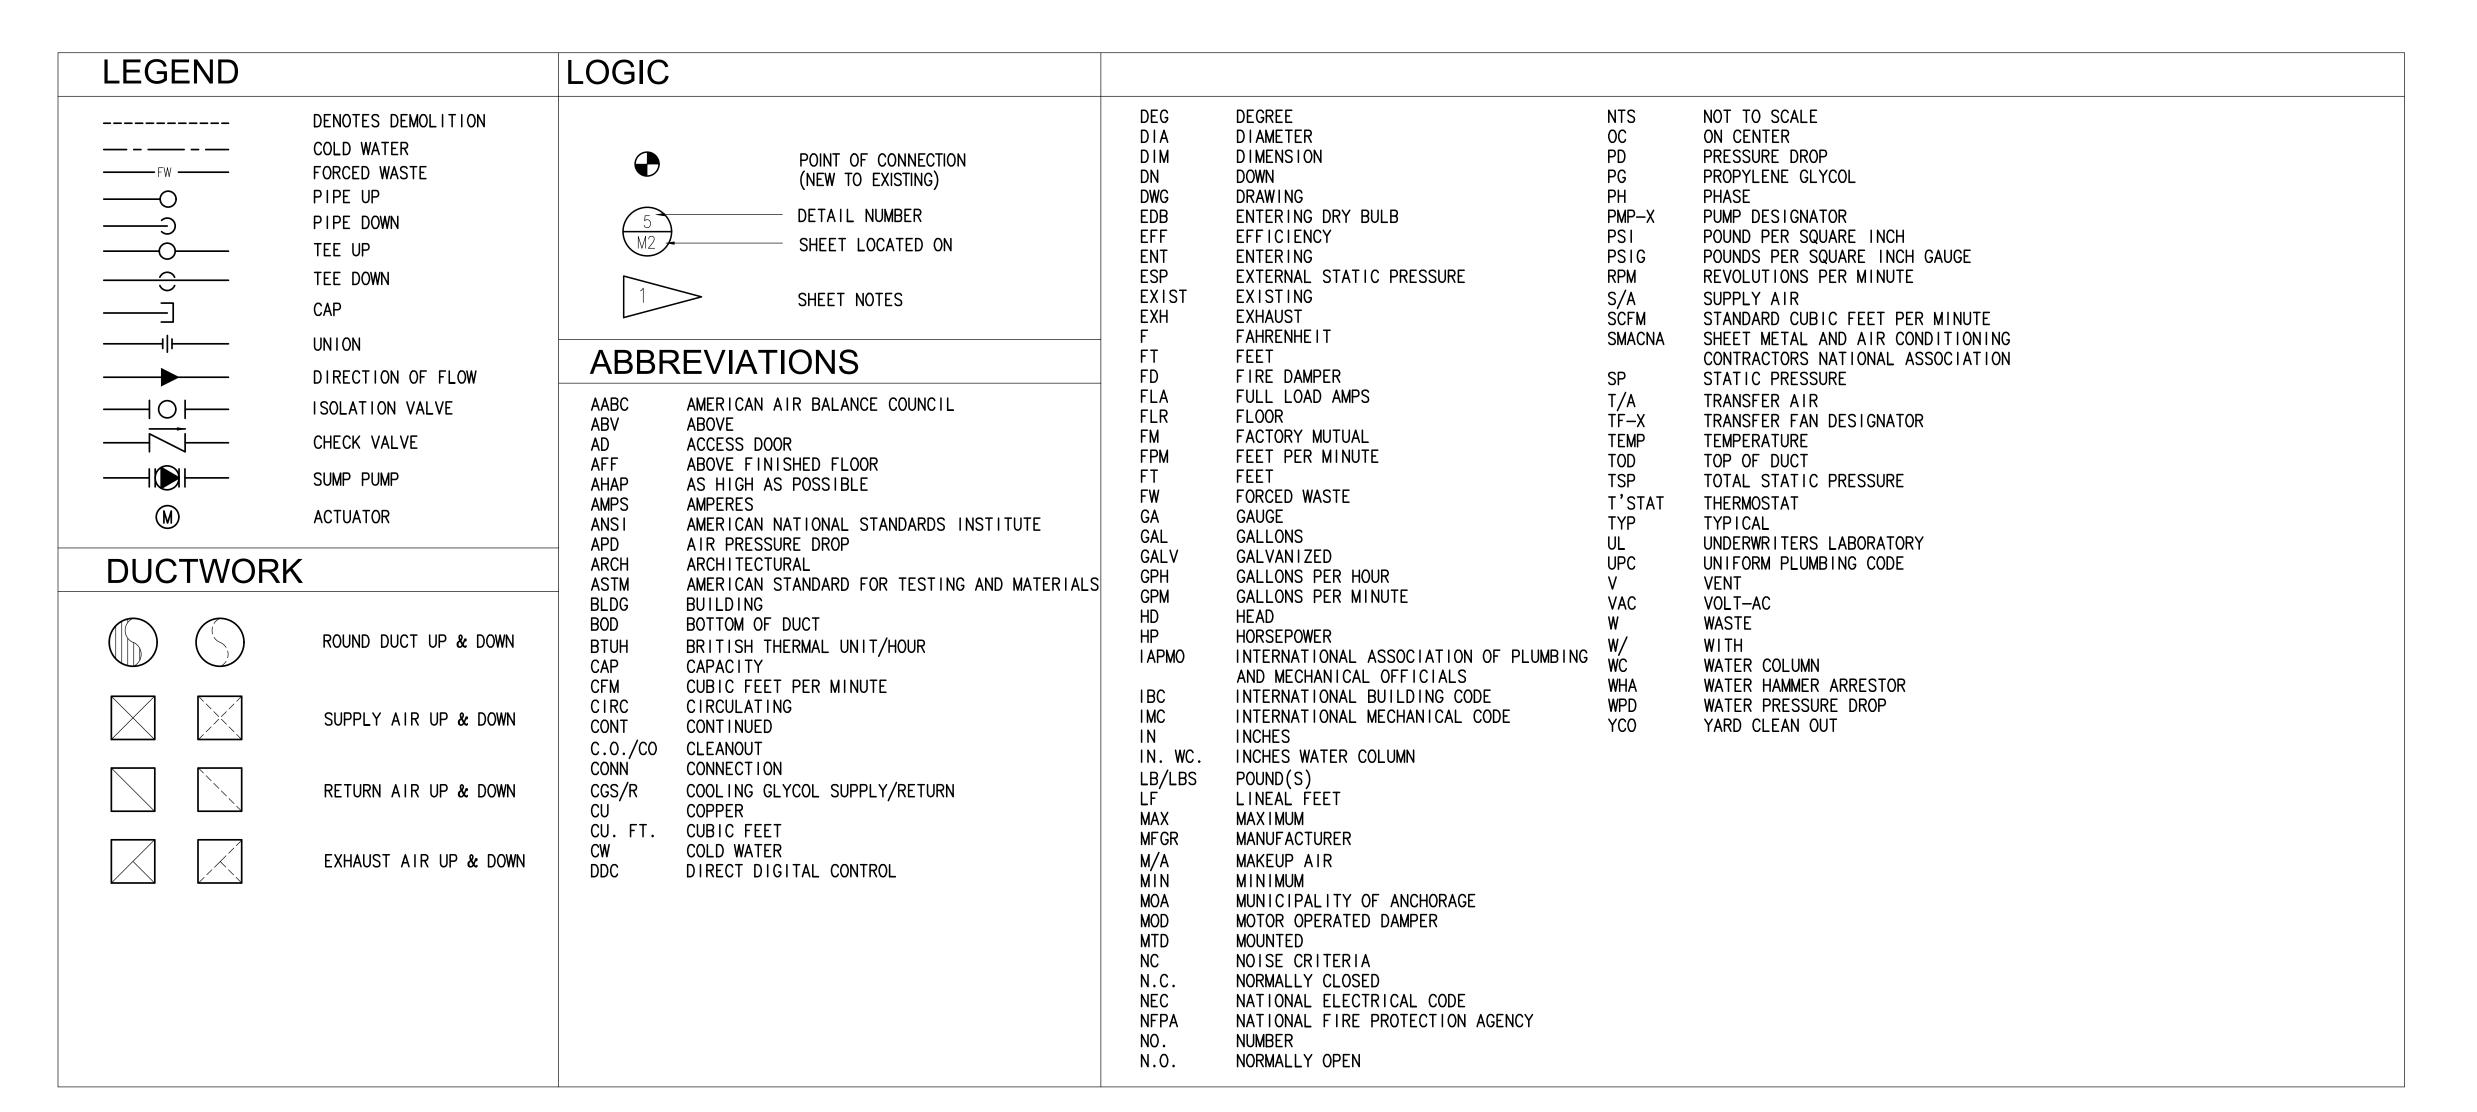

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A R B H I T E G T S LLE

Treet Suite 302 | Anchorage Alaska 99501

Mechanical and Electrical Consulting Engineers
670 West Fireweed Lane, Suite 200
Anchorage, AK 99503
(907)276-0521

FORMING ARTS CENTER /ATOR MODERNIZATION W 6TH AVE ANCHORAGE, ALASKA 99501

DATE: 3/9/22

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CHECKED: AJS

PROJECT: M1264


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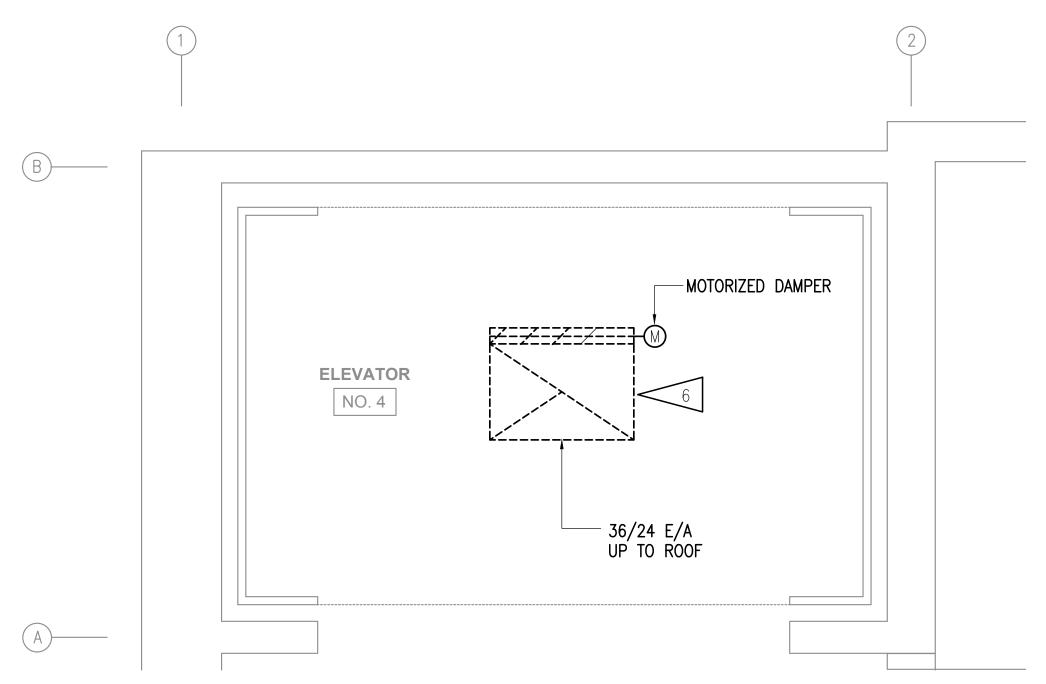
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LEGEND, SCHEDULES AND ABBREVIATIONS

REVISIONS:

SHEET NO:



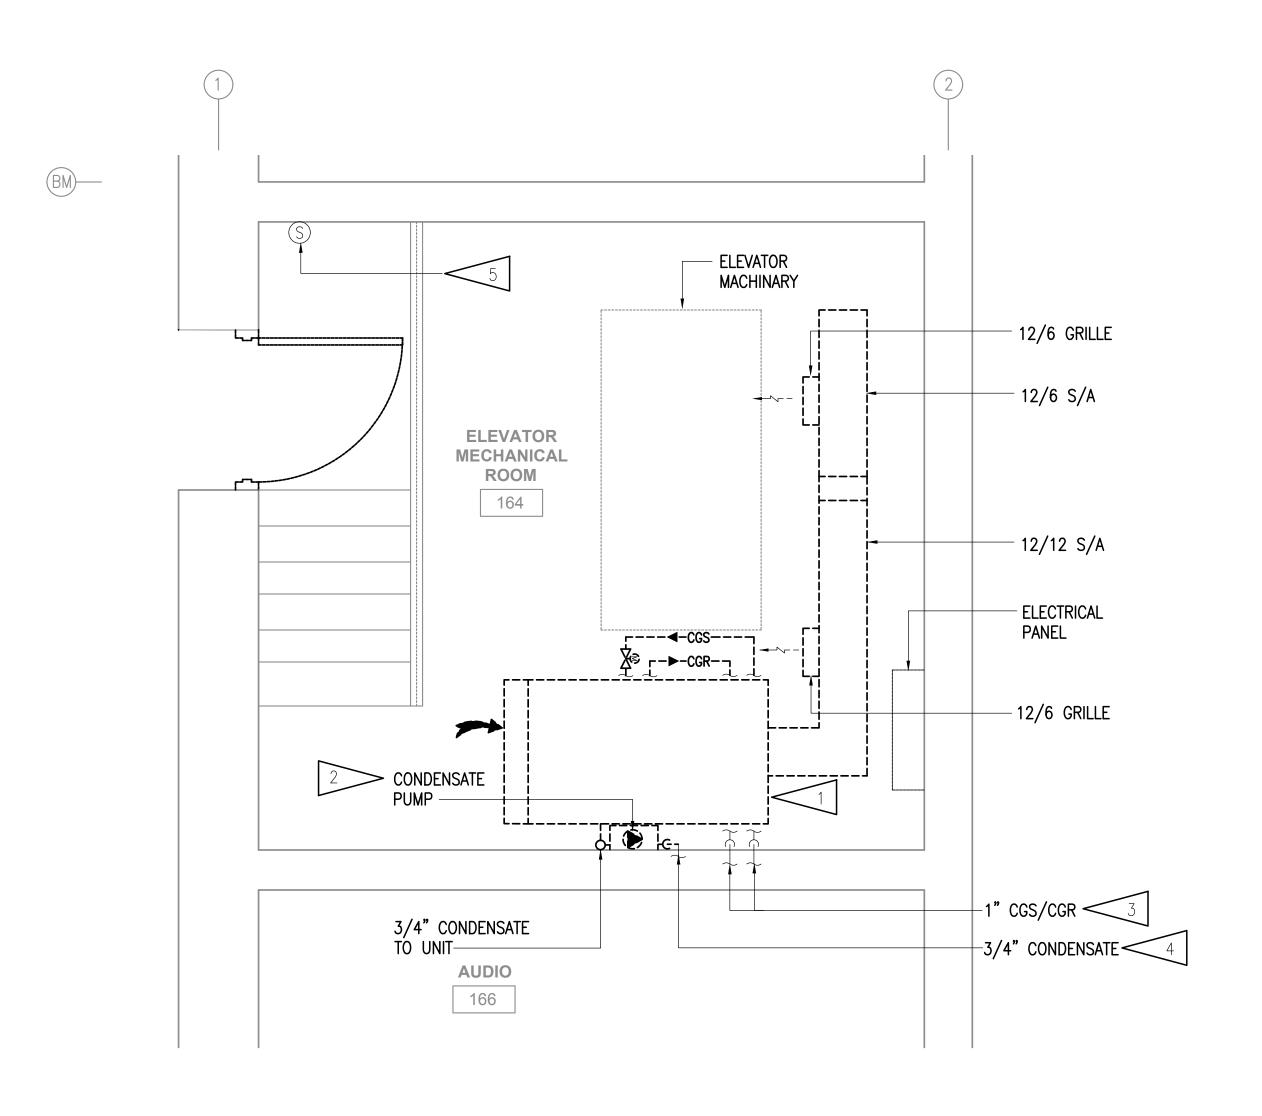

1 ELEVATOR DEMOLITION PLAN - MACHINE ROOM



2 ELEVATOR DEMOLITION PLAN - TOP OF HOISTWAY



GENERAL NOTES:

- A. THE INFORMATION SHOWN ON THIS DRAWING IS TAKEN FROM AS-BUILT DRAWINGS AND A NON-DESTRUCTIVE WALK THROUGH OF THE FACILITY. THE CONTRACTOR SHALL FIELD VERIFY ALL ITEMS SCHEDULED FOR DEMOLITION PRIOR TO START OF WORK.
- B. DASHED OR DOTTED LINES INDICATE ITEMS TO BE REMOVED. SOLID LINES INDICATE EXISTING ITEMS TO REMAIN.

DEMOLITION NOTES:

DEMOLISH FAN COIL UNIT, ASSOCIATED DUCTWORK, VALVES, COILS AND ALL ASSOCIATED APPURTENANCES.


DEMOLISH CONDENSATE PUMP, AND ALL ASSOCIATED APPURTENANCES.

DEMOLISH CGS/CGR PIPING AS HIGH AS POSSIBLE AND CAP.

DEMOLISH CONDENSATE PIPING AS HIGH AS POSSIBLE AND CAP.


> EXISTING TEMPERATURE SENSOR TO REMAIN.

- DEMOLISH HOISTWAY VENT IN ITS ENTIRETY. CAP AND INSULATE PER ARCHITECTURAL.

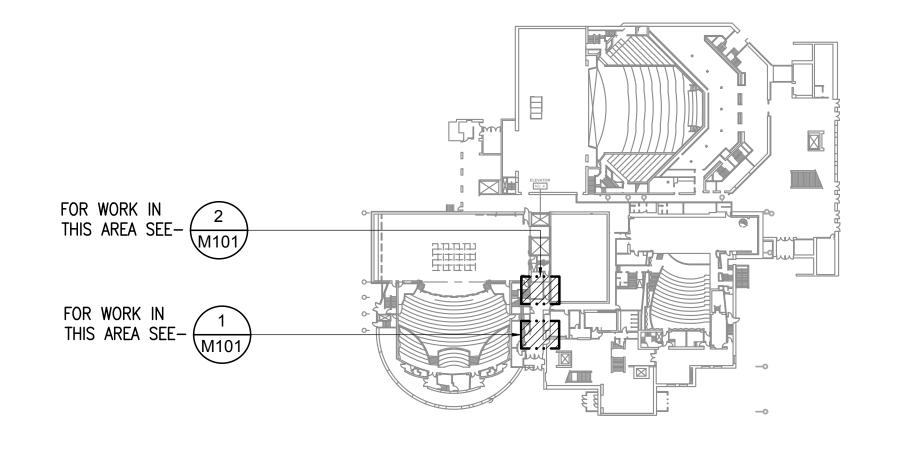

KEY PLAN

NOT TO SCALE

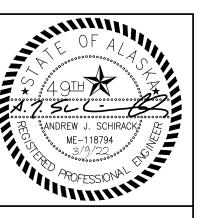

TE GT S LLe
Anchorage Alaska 99501
w.burkhart-croft.com

ARGHITEGT
880 N Street Suite 302 | Anchorage A

Mechanical and Electrical Consulti Engineers
670 West Fireweed Lane, Suite 200

PERFORMING ARTS CEN ELEVATOR MODERNIZAT

DATE: 3/9/22


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PROJECT: M1264
DRAWING TITLE:

DRAWING TITLE:
DEMOLITION PLANS

REVISIONS:

SHEET NO:



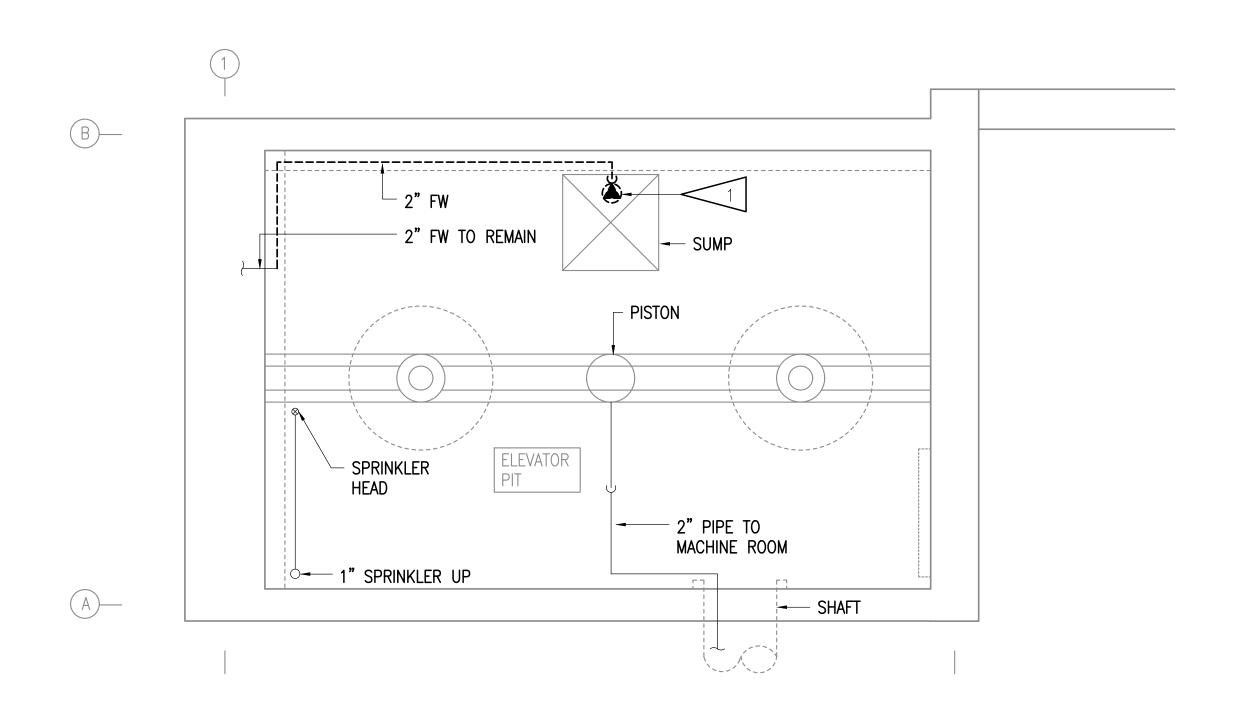




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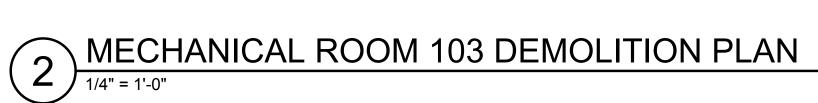
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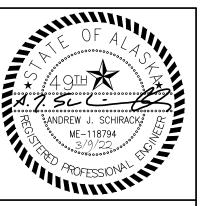
DEMOLITION NOTES:

DEMOLISH SUMP PUMP, PMP-40 AND ALL ASSOCIATED APPURTENANCES. DEMOLISH FORCED WASTE PIPING TO EXTENT SHOWN.

DEMOLISH SUMP PUMP, PMP-30 AND ALL ASSOCIATED APPURTENANCES. SEE REMODEL FOR REPLACEMENT.





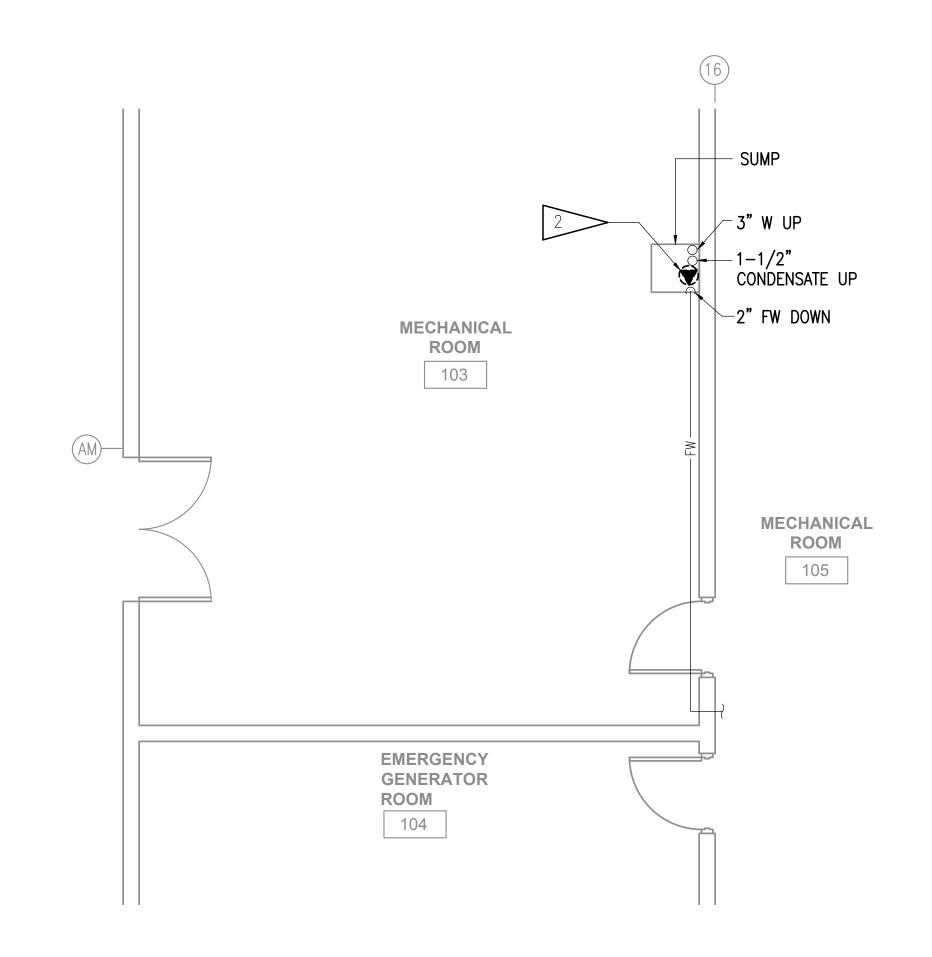

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Mechanical and Electrical Consultin Engineers
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Anchorage, AK 99503

FINTER Med Elect Elect Engineers Eng

PERFORMING ARTS CENTELEVATOR MODERNIZAT
621 W 6TH AVE ANCHORAGE, ALASKA 998

DATE: 3/9/22


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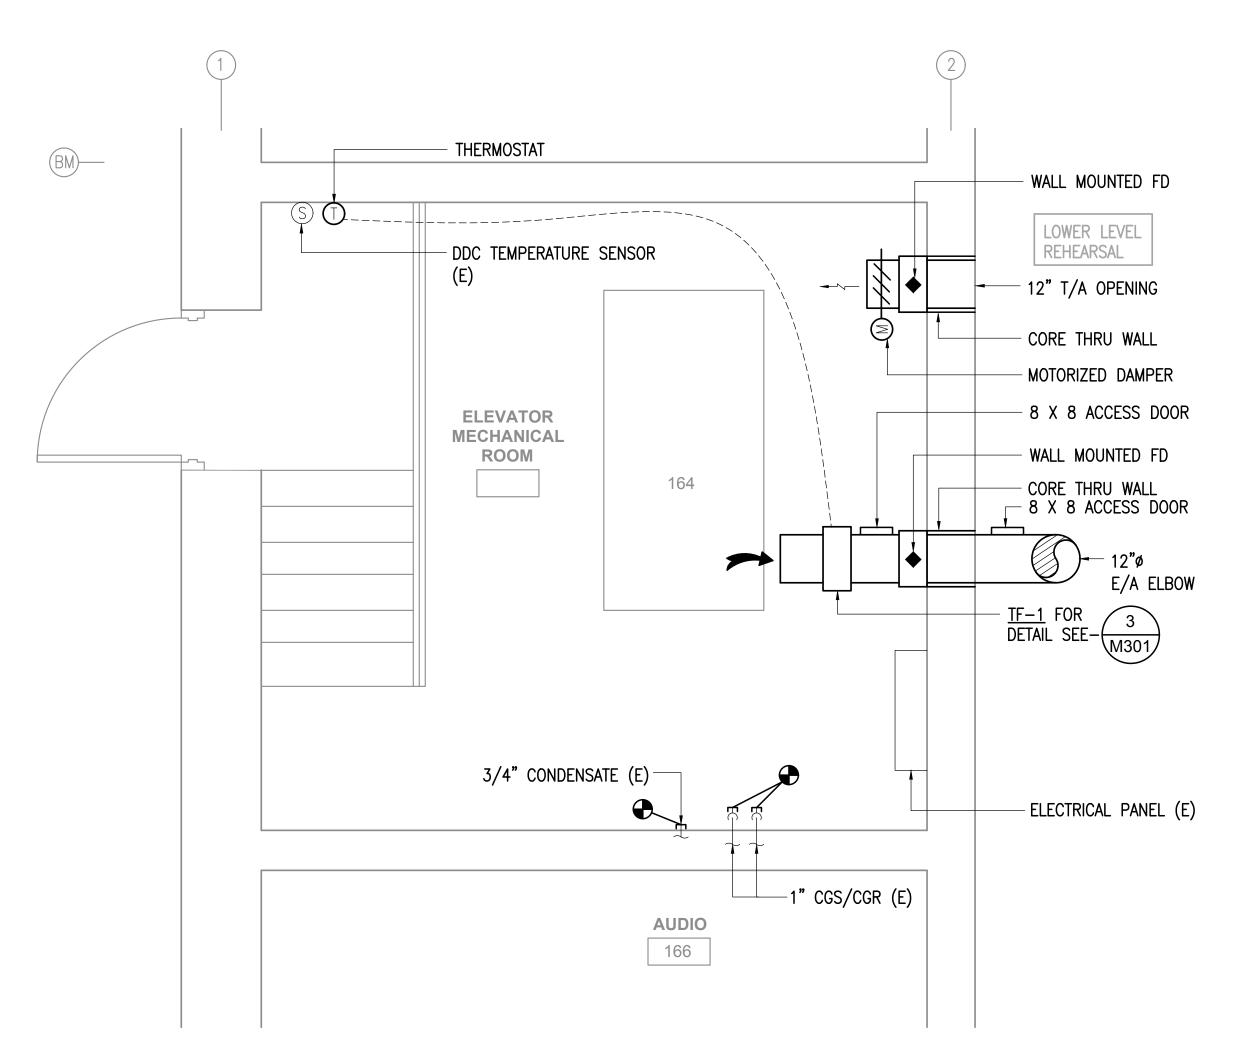
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DRAWING TITLE:
DEMOLITION PLANS

REVISIONS:


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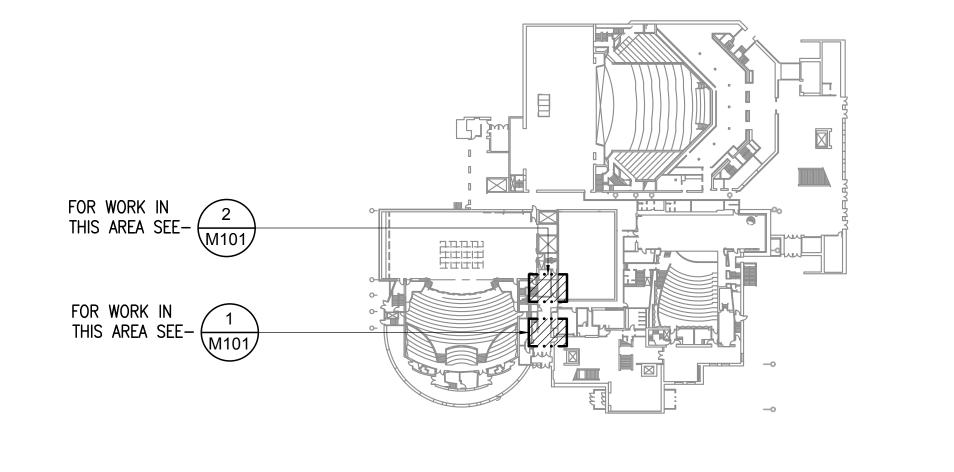
ELEVATOR REMODEL PLAN - MACHINE ROOM

1/2" = 1'-0"

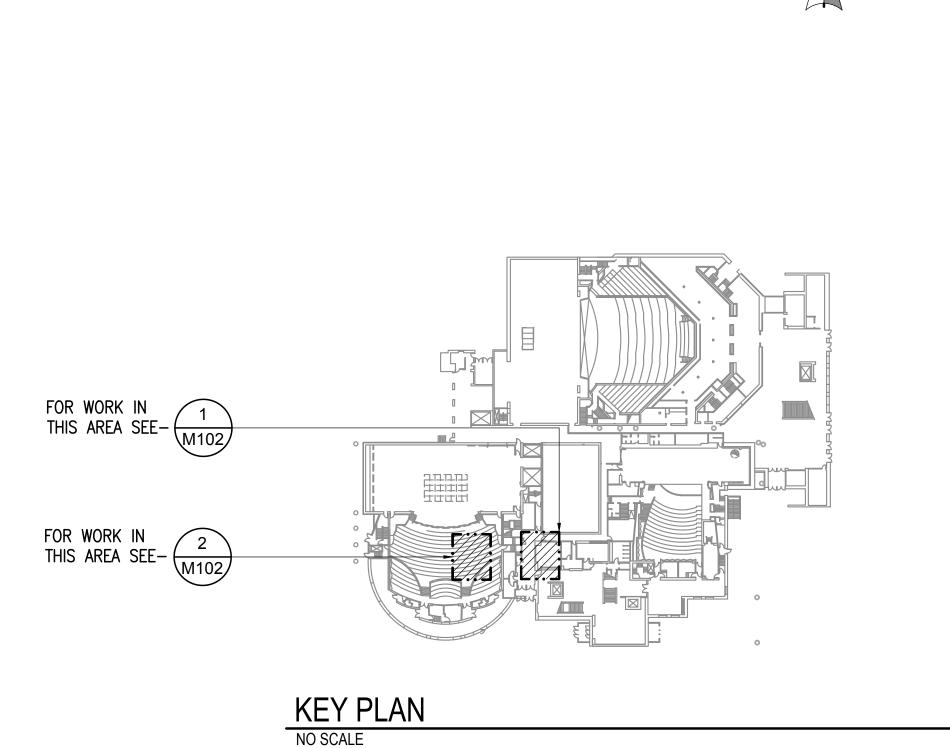


ELEVATOR REMODEL PLAN - TOP OF HOISTWAY

1/2" = 1'-0"

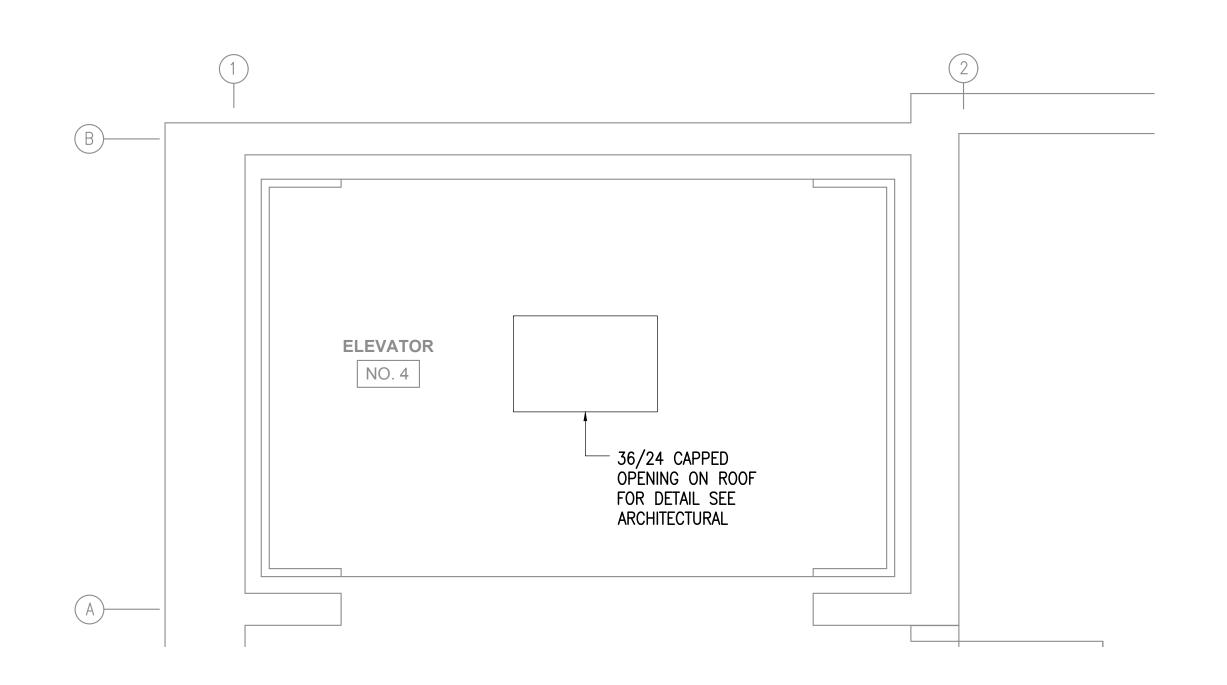

KEY PLAN

NOT TO SCALE

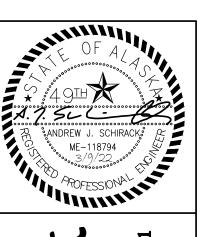

I T E G T S LLe

Anchorage Alaska 99501

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670 West Fireweed Lane, Suite 200
Anchorage, A 89503

ZATION E

PERFORMING ARTS CEN ELEVATOR MODERNIZAT 621 W 6TH AVE ANCHORAGE, ALASKA 99

MUNICIPALITY OF

DATE: 3/9/22


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CHECKED: AJS


PROJECT: M1264
DRAWING TITLE:


REMODEL PLANS

REVISIONS:

SHEET NO:

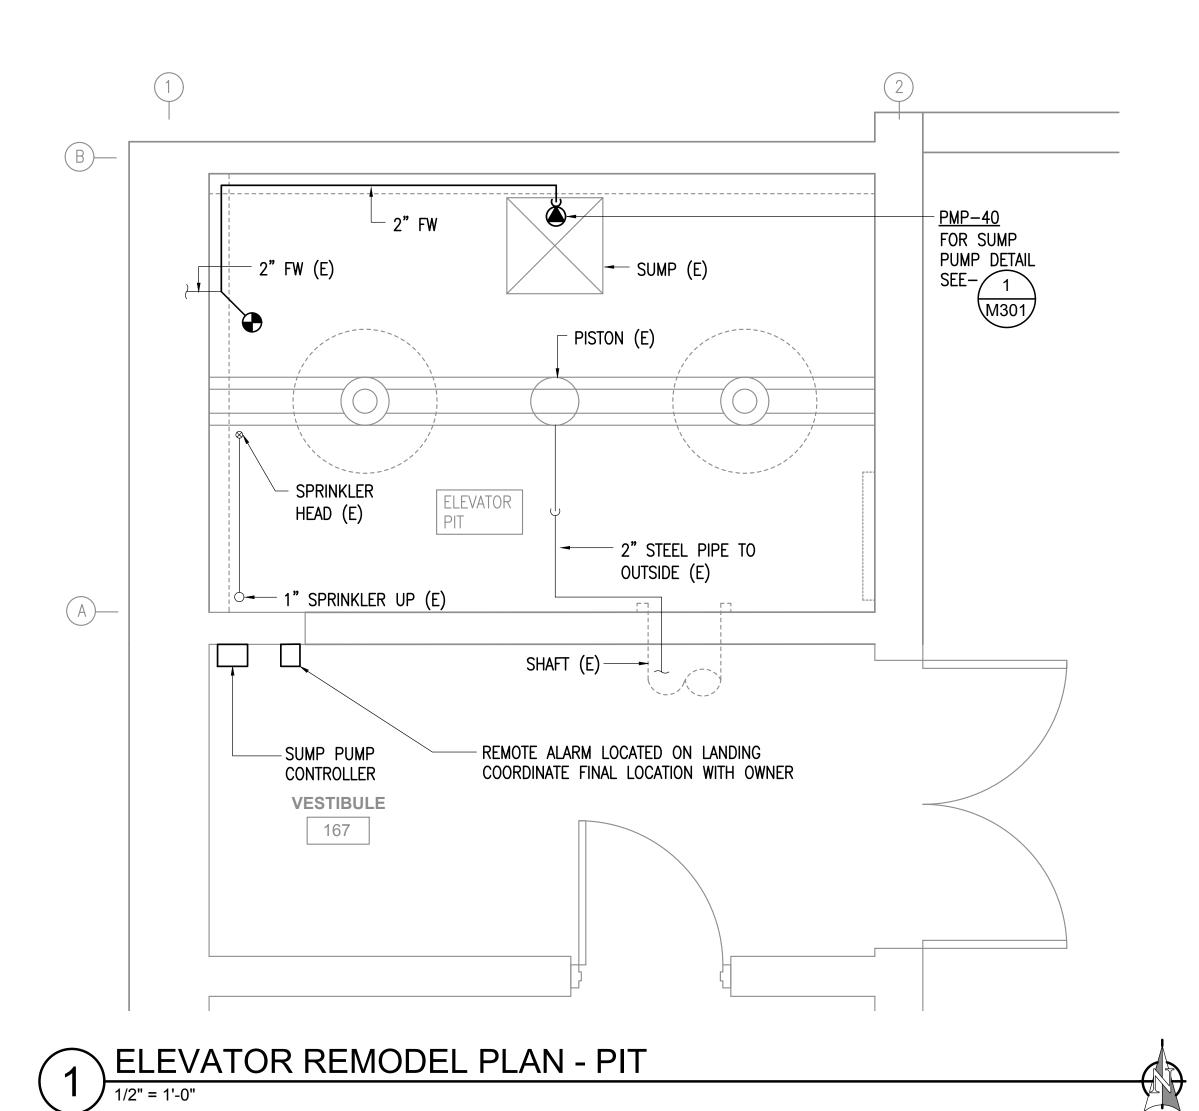


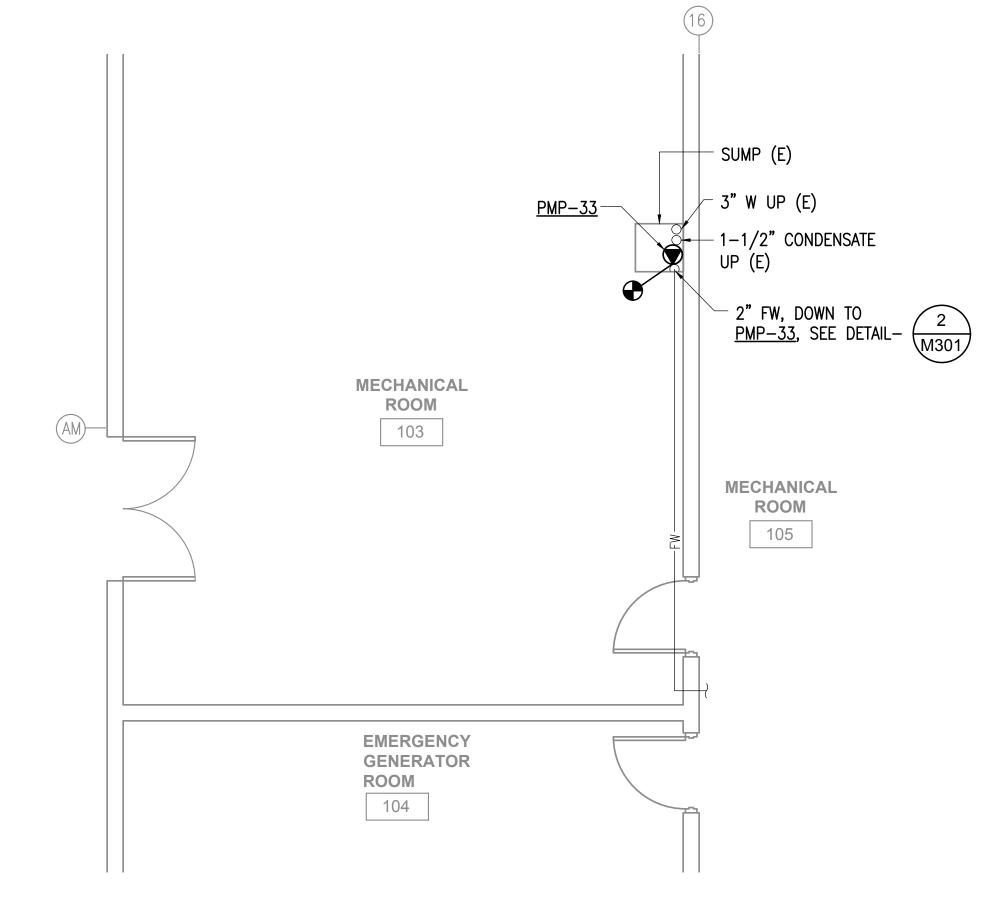

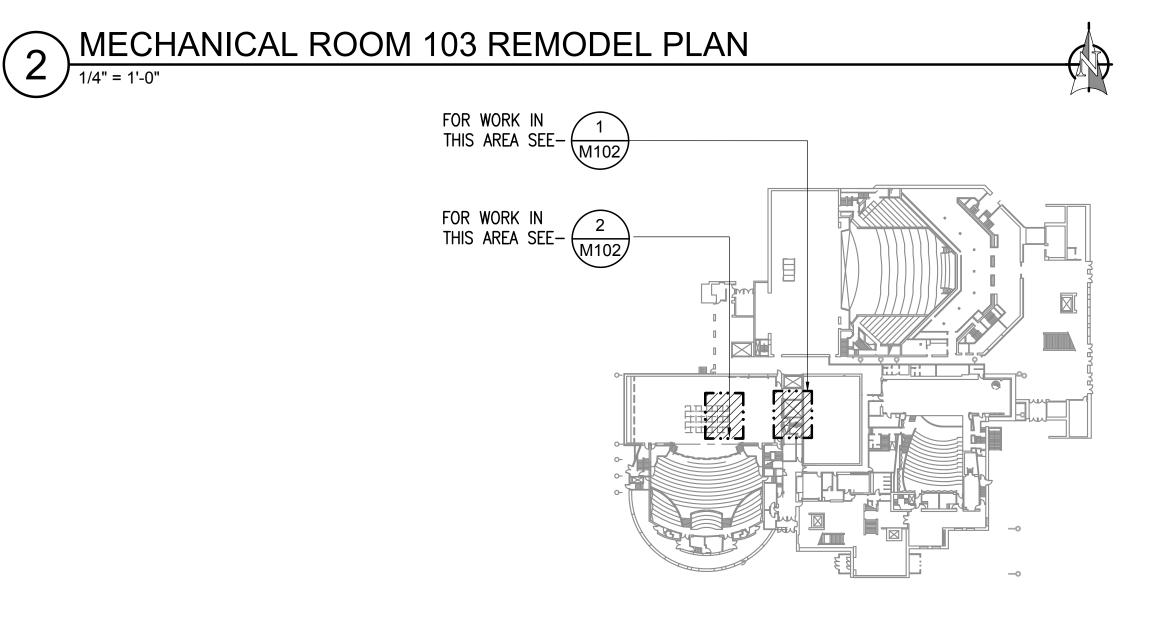

KEY PLAN

NOT TO SCALE

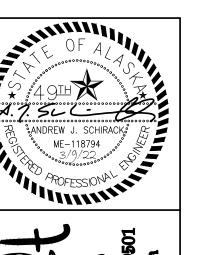

Anchorage Alaska 99501

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PERFORMING ARTS CEN ELEVATOR MODERNIZATOR WOTH AVE ANCHORAGE, ALASKA 99

DATE: 3/9/22

MUNICIPALITY OF


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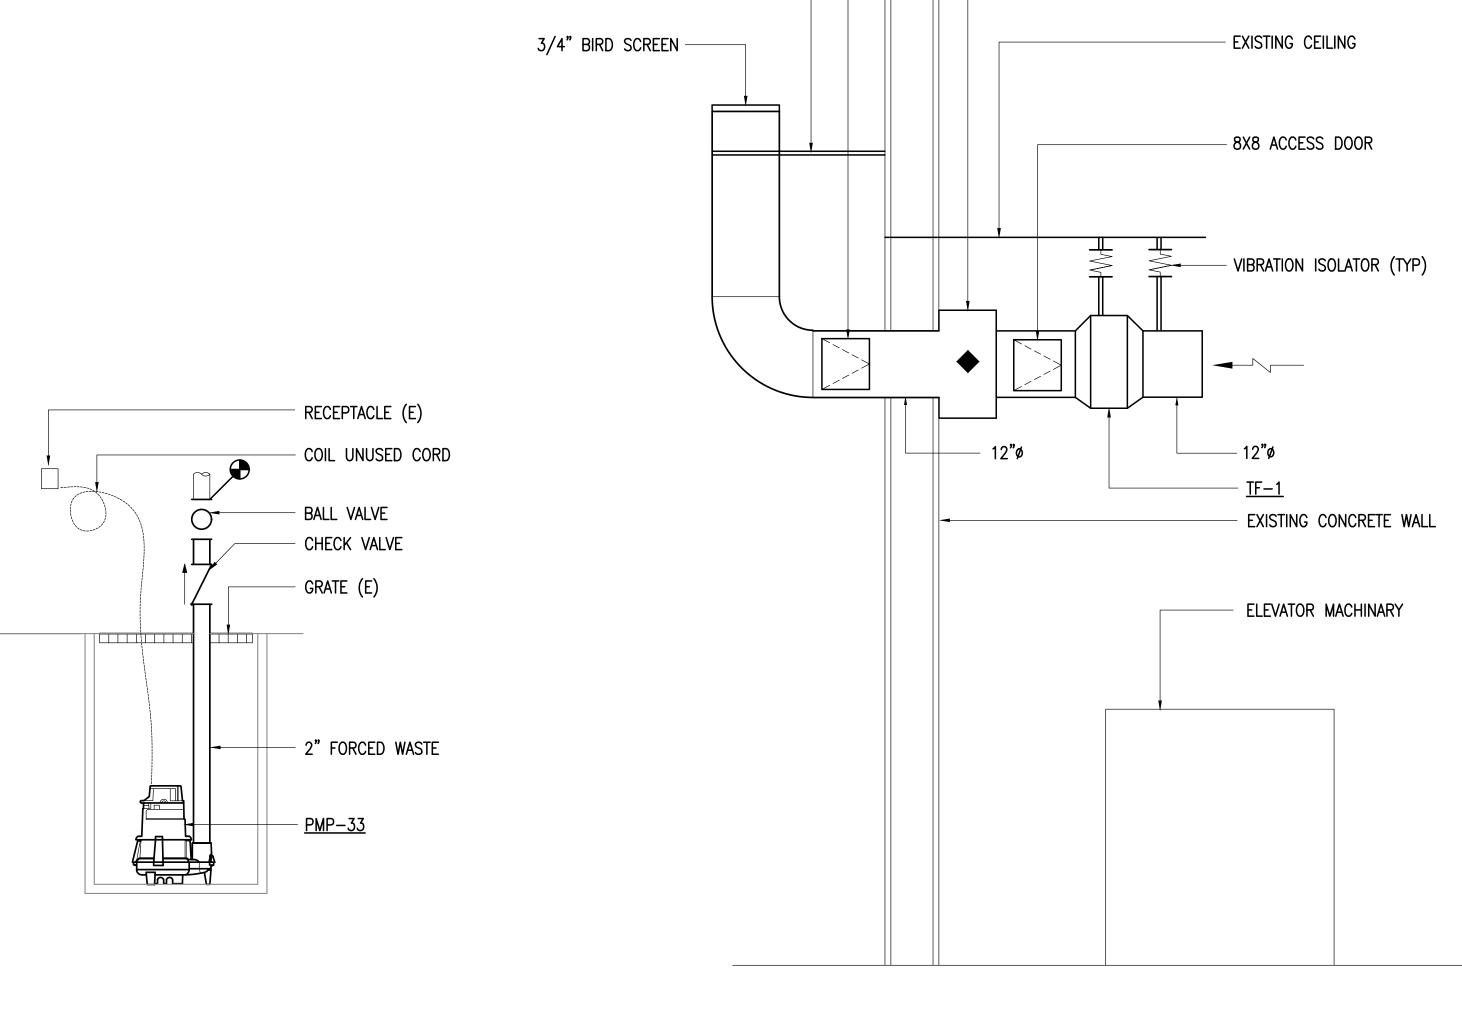
PROJECT: M1264

DRAWING TITLE: REMODEL PLANS

REVISIONS:

SHEET NO:



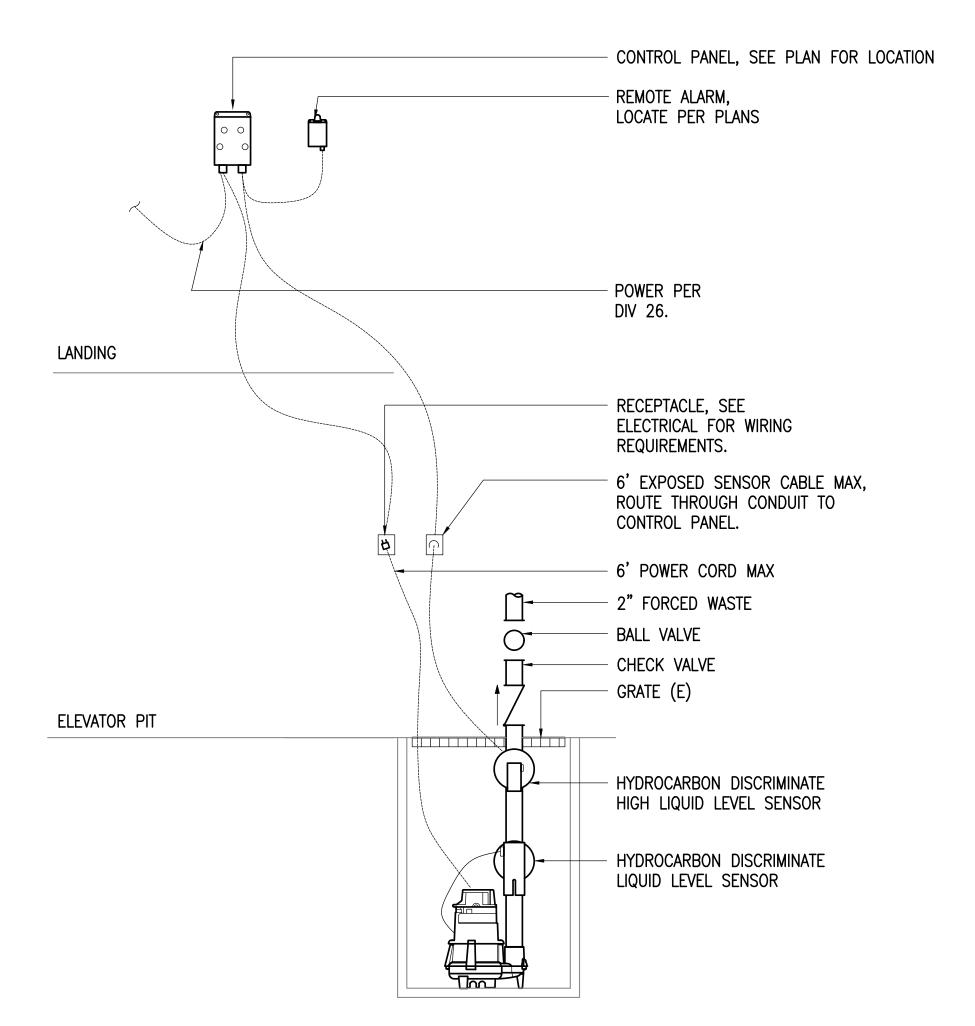

SUPPORT AS NECESSARY

1 ELEVATOR SUMP PUMP DETAIL

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MECH ROOM 103 SUMP PUMP DETAIL

NOT TO SCALE

3 EXHAUST FAN DETAIL
NOT TO SCALE

ANDREW J. SCHIRACKS

ME-118794

AROFESSIONA

Mart Creent
BITE BITS LLB
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- 8 X 8 ACCESS DOOR

- WALL MOUNTED FD

rical Consulting
Neers
Fireweed Lane, Suite 200
AX 99503
S521
No.: AECC542
T: 9

Mechanical Electrical CC Engineers 670 West Fireweed Lane Anchorage, AK 99503 (907)276-0521

PERFORMING ARTS CENTER ELEVATOR MODERNIZATION 621 W 6TH AVE ANCHORAGE, ALASKA 99501

DATE: 3/9/22

CHECKED: AJS

DRAWN: SR

PROJECT: M1264

DRAWING TITLE:
DETAILS

REVISIONS:

SHEET NO:

	LE	GEND	
Ю	LIGHT FIXTURE - SURFACE MTD ON WALL	ф	DUPLEX RECEPTACLE TO BE REMOVED (DASHED OR DOTTED LINES INDICATE ITEMS TO BE REMOVED TYPICAL)
	2X2 LIGHT FIXTURE - RECESSED		NOTE TAG (No. INDICATES NOTE)
	LINEAR LIGHT FIXTURE - SURFACE MTD	AFF	ABOVE FINISHED FLOOR
0 0	LINEAR LIGHT FIXTURE — PENDANT MTD	ATS	AUTOMATIC TRANSFER SWITCH
A	FIXTURE TAG (LETTER INDICATES TYPE)	С	CONDUIT
\$	SINGLE POLE SWITCH	CO	CONDUIT ONLY
	CONDUIT	E	DENOTES EXISTING ITEM
#10	NUMBER AND SIZE OF WIRES (NO MARKS = 3 #12)	EM	DENOTES EMERGENCY POWER
A-2	HOMERUN TO PANEL (PANEL AND CIRCUIT No.)	FACP	FIRE ALARM CONTROL PANEL
	PANEL	GFCI	GROUND FAULT CIRCUIT INTERRUPTER
Ф	DUPLEX RECEPTACLE	К	KELVIN
47	DUPLEX RECEPTACLE WITH GROUND FAULT CIRCUIT INTERRUPTER	LED	LIGHT EMITTING DIODE
Ф	SIMPLEX RECEPTACLE	LM	LUMENS
(JUNCTION BOX	NEC	NATIONAL ELECTRICAL CODE
%	MOTOR (SIZED AS NOTED)	NTS	NOT TO SCALE
B	DISCONNECT SWITCH (FUSED)	R	DENOTES EXISTING ITEM THAT HAS BEEN RELOCATED
FCP	FIRE ALARM CONTROL PANEL	TYP	TYPICAL
0	HEAT DETECTOR 135' & RATE OF RISE (OR FIXED 'F IF NOTED)	UON	UNLESS OTHERWISE NOTED
②	PHOTOELECTRIC SMOKE DETECTOR		

	TO HWMDS ⊱	ASCO 7000 SERIES 600A ATS "TSSB" TO GENERATOR PANEL TRANSFER SIGNAL TO ELEVATOR CONTROLLERS W.C.R.
25 HP \$\(\rightarrow \)	ELEVATOR #2 CONTROLLER TO PANEL "SBW" SPARE CONTROLLER	PANEL "SSM" $ \begin{array}{c ccccccccccccccccccccccccccccccccccc$
25 HP 🔷	ELEVATOR #3 CONTROLLER	

ONE-LINE DIAGRAM - DEMOLITION


LIGHT FIXTURE SCHEDULE MOUNTING MANUFACTURER AND CATALOG TYPE LUMINAIRE DESCRIPTION LOCATION NUMBER (OR APPROVED EQUAL) LAMPS BALLAST/DRIVER WATTS TYPE HEIGHT 5.88"W x 24.0"L x 3.74"H LED SURFACE MOUNT NEMA SURFACE MATCH 4000K LED 120-277V LED **ELEVATOR** LITHONIA LIGHTING EXISTING 3662LM #DMW2-L24-3000LM-MVOLT DRIVER 4X GASKETED VAPORTIGHT FIXTURE WITH WHITE -MVOLT-GZ10-40K-80CRI FIBERGLASS HOUSING, POLYCARBONATE LENS, AND POLYMERIC LATCHES. 4FT NOMINAL STRIP FIXTURE, FROSTED DROP LENS, PENDANT | MATCH | 4000K LED | 120-277V LED | 59 **ELEVATOR** LITHONIA B MACHINE WHITE FINISH MOUNTED EXISTING | 7597LM | DRIVER #ZL1D-L48-7000LM-FST ROOM -MVOLT-40K-80CR-WH SAME AS TYPE "B" EXCEPT LOWER LUMEN OUTPUT LOWER LITHONIA MATCH | 4000K LED | 120-277V LED | 41 EXISTING | 5541LM | DRIVER REHEARSAL #ZL1D-L48-5000LM-FST PENDANT 5TH FLOOR -MVOLT-40K-80CR-WH MOUNTED LANDINGS RECESSED CEILING 4000K LED 120-277V LED 31 BASEMENT LITHONIA 2'W x 2'W x 1.7"H LED RECESSED MOUNT FIXTURE 3767LM DRIVER WITH ALUMINUM FRAME AND SATIN WHITE DIFFUSER #CPX-2X2-3200LM-80CRI -40K-SWL-MIN10-ZT-MVOLT +7'-6" 4000K LED 120-277V LED 8 3RD FLOOR GOTHAM 4" CYLINDRICAL LED WALL MOUNT FIXTURE WITH #EVO4WC-40/07-AR-MWD LANDING ALUMINUM HOUSING, CLEAR REFLECTOR WITH MATTE MOUNTED AFF 808LM DRIVER -LD-MVOLT-GZ10-JBX-DN DIFFUSE FINISH, AND MEDIUM WIDE DISTRIBUTION

GENERAL NOTES:


A. THE ELEVATOR IS PERFORMANCE SPECIFIED AND BASED AROUND A 60HP, 480V, 3Ø MOTOR OR ALTERNATE 50HP, 480V, 3Ø SUBMERSIBLE MOTOR. ELECTRICAL CONTRACTOR SHALL PROVIDE APPROPRIATELY SIZED (PER NEC) CONDUCTORS AS WELL AS FUSES IN DISCONNECT FOR CHOSEN MOTOR SIZE.

SHEET NOTES

- 1. DEMOLISH ELEVATOR CONDUIT AND CONDUCTORS BACK TO DISCONNECT.
- 2. COORDINATE WITH ASCO TO PROVIDE AND INSTALL 31Z ELEVATOR PRE/POST TRANSFER SIGNAL ACCESSORY AND CONNECT TO NEW ELEVATOR CONTROLLER.

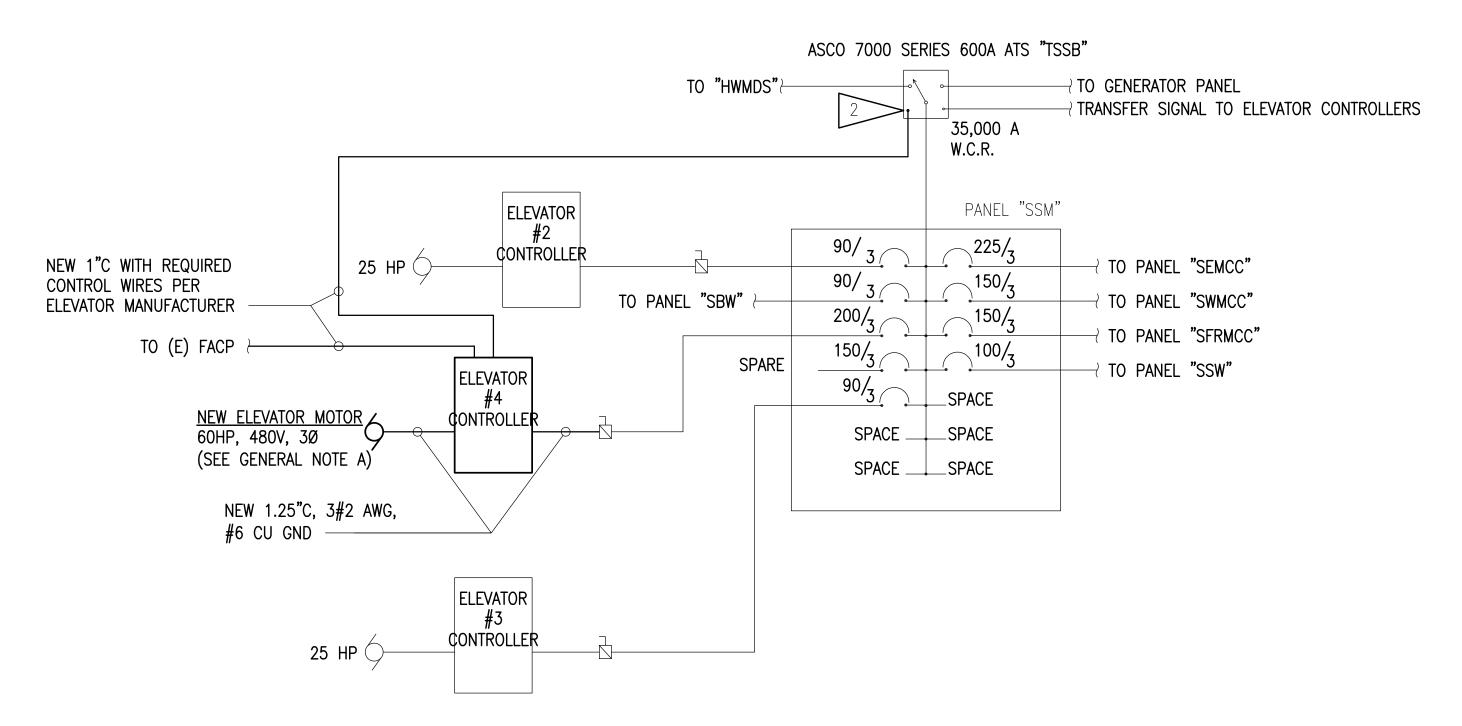



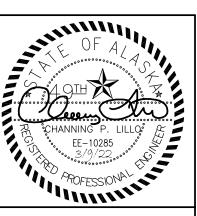

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RSSA
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CENTER

FORMING ARTS CENTATOR MODERNIZAT
W 6TH AVE ANCHORAGE, ALASKA 998

MUNICIPALITY OF

DATE: 3/9/22
DRAWN: KWS,FWS

PERI ELE 621

CHECKED: KWS,CPL PROJECT: M1264

DRAWING TITLE:

LEGEND, SCHEDULES AND ABBREVIATIONS


REVISIONS:

SHEET NO:

MFF	R/MC	DEL:	?	Ì	VOLTS: 120/208	V,3PH,4\	W	El	NCLOSURE	: NEMA 1		225	Α			
						VOLT-A	AMPS		MTG	MTG: SURFACE						
CIRC	POLE	AMPS	SERVICE	TYPE	A	Е	3	С	TYPE	SERVICE	AMPS	POLE	CIRC	NOTE		
1	1	20	TOILETS, SHOWERS							OFFICE OUTLET	20	1	2	а		
3	1	20	ELEVATOR PIT LTG	MISC		112				GREEN RM OUTLET	20	1	4	a		
5	1	20	ELEVATOR PIT SUMP PUMP	MOTR				1127		GREEN RM OUTLET	20	1	6	a		
7	1	20	ELEVATOR PIT RECP	RECP	180					GREEN RM OUTLET	20	1	8	a		
9	1	20	SPARE			***************************************				CORRIDOR OUTLET	20	1	10	a		
11	1	20	DRESS ROOM 193					-		PIT LIFT OUTLET	20	1	12	a		
13	1	20	DRESS ROOM 193							PIT LIFT CONTROLS	20	1	14	а		
15	1	20	DRESS ROOM 194	2		-				TOOL ROOM OUTLETS	20	1	16	а		
17	1	20	DRESS ROOM 194					Постороння		TOOL ROOM OUTLETS	20	1	18	a		
19	1	20	DRESS ROOM 156							TOOL ROOM OUTLETS	20	1	20	a		
21	1	20	DRESS ROOM 156		42	-	180		RECP		20	1	22	C		
23	1	20	DRESS ROOM 157			-				SF-40	20	1	24	а		
25	1	20	DRESS ROOM 157		166				MOTE	EF-1 ELEV. EXHAUST	20	1	26	-		
27	1	20	DRESS ROOM 160		1.47					SPARE	20	1	28	+		
29	1	20	DRESS ROOM 160							SPARE	20	1	30	-		
31	1	20	DRESS ROOM 160							ROOM 166 OUTLETS	20	1	32	а		
33	1	20	DRESS ROOM 160			-				ROOM 166 OUTLETS	20	1	34	а		
35	1	20	DRESS ROOM 160	3				полити		ROOM 166 OUTLETS	20	1	36	а		
37	1	20	AUDIO							SPARE	20	1	38	а		
39	2	20	(E) UNKNOWN		(4)	***************************************				GREEN RM COOK TOP	20	2	40	_		
41	2	20	M					минини		^^	20	2	42	а		
EXI	STIN STIN	G SP	AD TO REMAIN ARE BREAKER TO BE CONNE EAKER TO BE USED FOR NEV		NEW LOAD IND	DICATED				L OPTIONS: LUGS ONLY			o :			

EXISTING LOADS REMOVED ((IN KVA):				
DITLITO	<u> </u>	20	\		
PIT LTG PIT RECEP		180	VA VA		
SUMP PUMP		1,127			
SF-39		1,127			
		· , · — ·	VA		
	SUBTOTAL:	2,494	VA		
TOTAL LOADS REMOVED:				-2,494 V	A
TOTAL LOADS REMOVED (IN	AMPS):			-7 A	
NEW LOADS ADDED (IN KVA)	1				
ELEVATOR PIT LTG		112	VA		
ELEVATOR PIT RECP			VA		
SP-1		1,127			
EF-1	SUBTOTAL:	1,585	VA VA		
TOTAL LOADS ADDED:				1,585 V	A
TOTAL LOADS ADDED (IN AN	/IPS):			4 A	
NET LOAD CHANGE:				-909 V	A
NET LOAD CHANGE (IN AMPS	5) :			-3 A	

ELECTRICAL LOAD CALC	ULATION PANEL "WWB"
EXISTING LOADS REMOVED (IN VA): 2-LAMP T8 STRIP FIXTURE (5) SUBTOTAL:	300 VA 300 VA
TOTAL LOADS REMOVED:	-300 VA
TOTAL LOADS REMOVED (IN AMPS):	-0.83 A
NEW LOADS ADDED (IN VA) TYPE B (3) TYPE C (1) TYPE D (1) SUBTOTAL:	177 VA 41 VA 31 VA 249 VA
TOTAL LOADS ADDED:	249 VA
TOTAL LOADS ADDED (IN AMPS):	0.69 A
NET LOAD CHANGE:	-51 VA
NET LOAD CHANGE (IN AMPS):	-0.14 A
RESULT: NET REDUCTION IN LOAD. EXISTIN HAVE CAPACITY FOR REMODEL.	G SERVICE AND BRANCH PANEL(S)

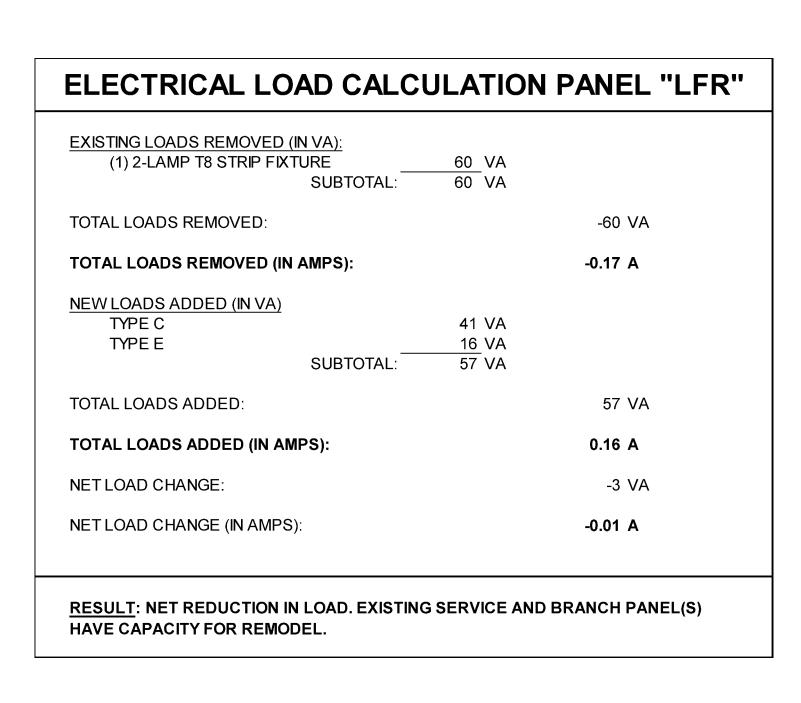


CHECKED: KWS, CPL

PROJECT: M1264

DRAWING TITLE:
ELECTRICAL
SPECIFICATIONS

REVISIONS:

SHEET NO:

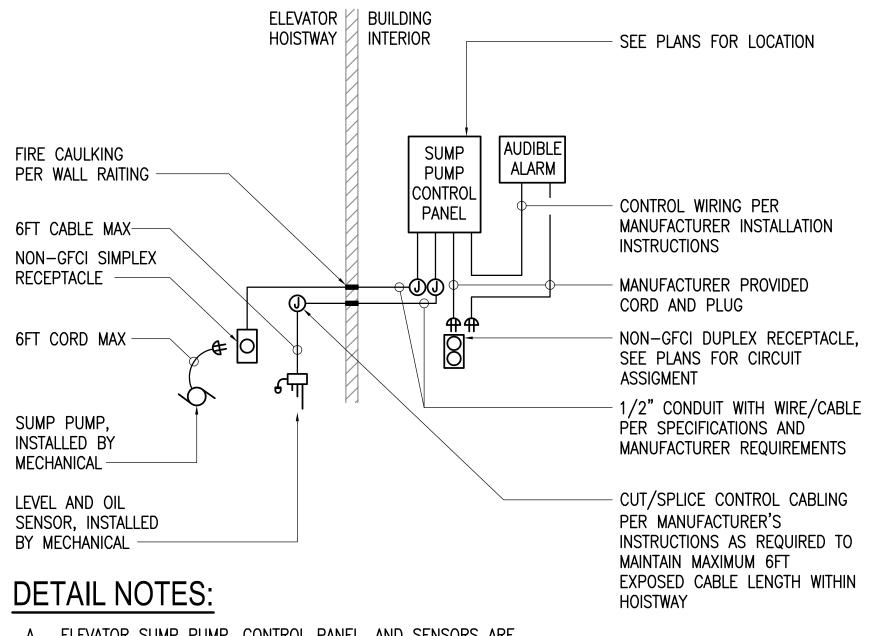

- A. ELEVATOR SUMP PUMP, CONTROL PANEL, AND SENSORS ARE PROVIDED BY MECHANICAL AND INSTALLED BY ELECTRICAL UNLESS OTHERWISE NOTED. BASIS OF DESIGN IS LIBERTY PUMPS #ELV-SERIES.
- B. ALL ELECTRICAL WORK WITHIN HOISTWAY SHALL COMPLY WITH WITH LATEST NEC ADOPTED CODE OF ARTICLE 620.

ELEVATOR SUMP PUMP DETAIL NO SCALE



CENTER

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DATE: 3/9/22

DRAWN: KWS CHECKED: KWS


PROJECT: M1264

DRAWING TITLE:

ELECTRICAL DETAILS

REVISIONS:

SHEET NO:

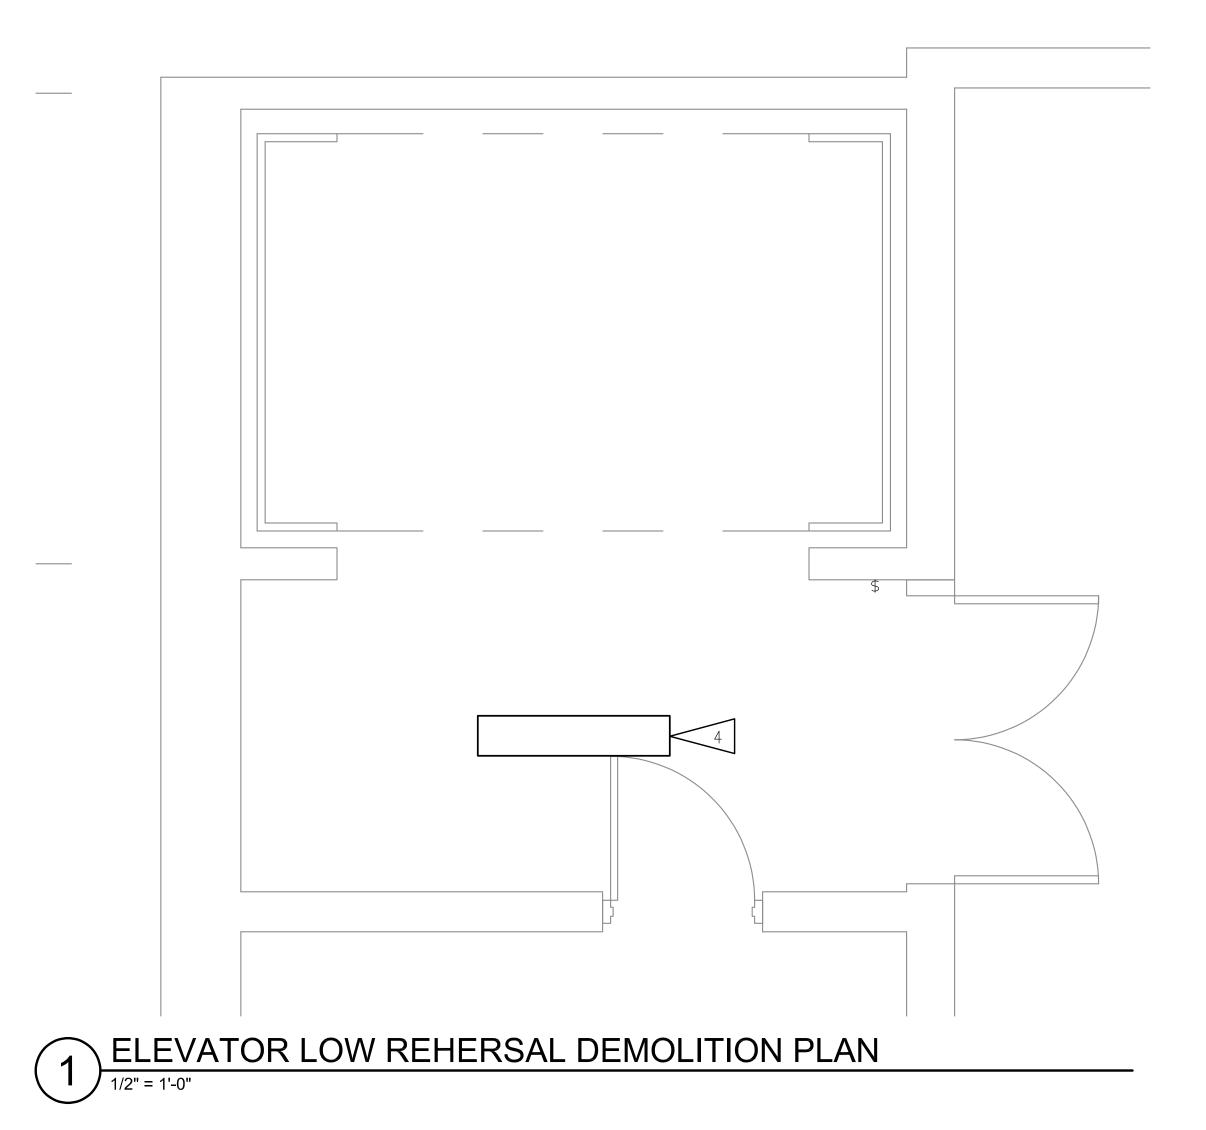


EXISTING SUMP PUMP

ELEVATOR STOP/START

PIT LICHTS
SWITCH

2

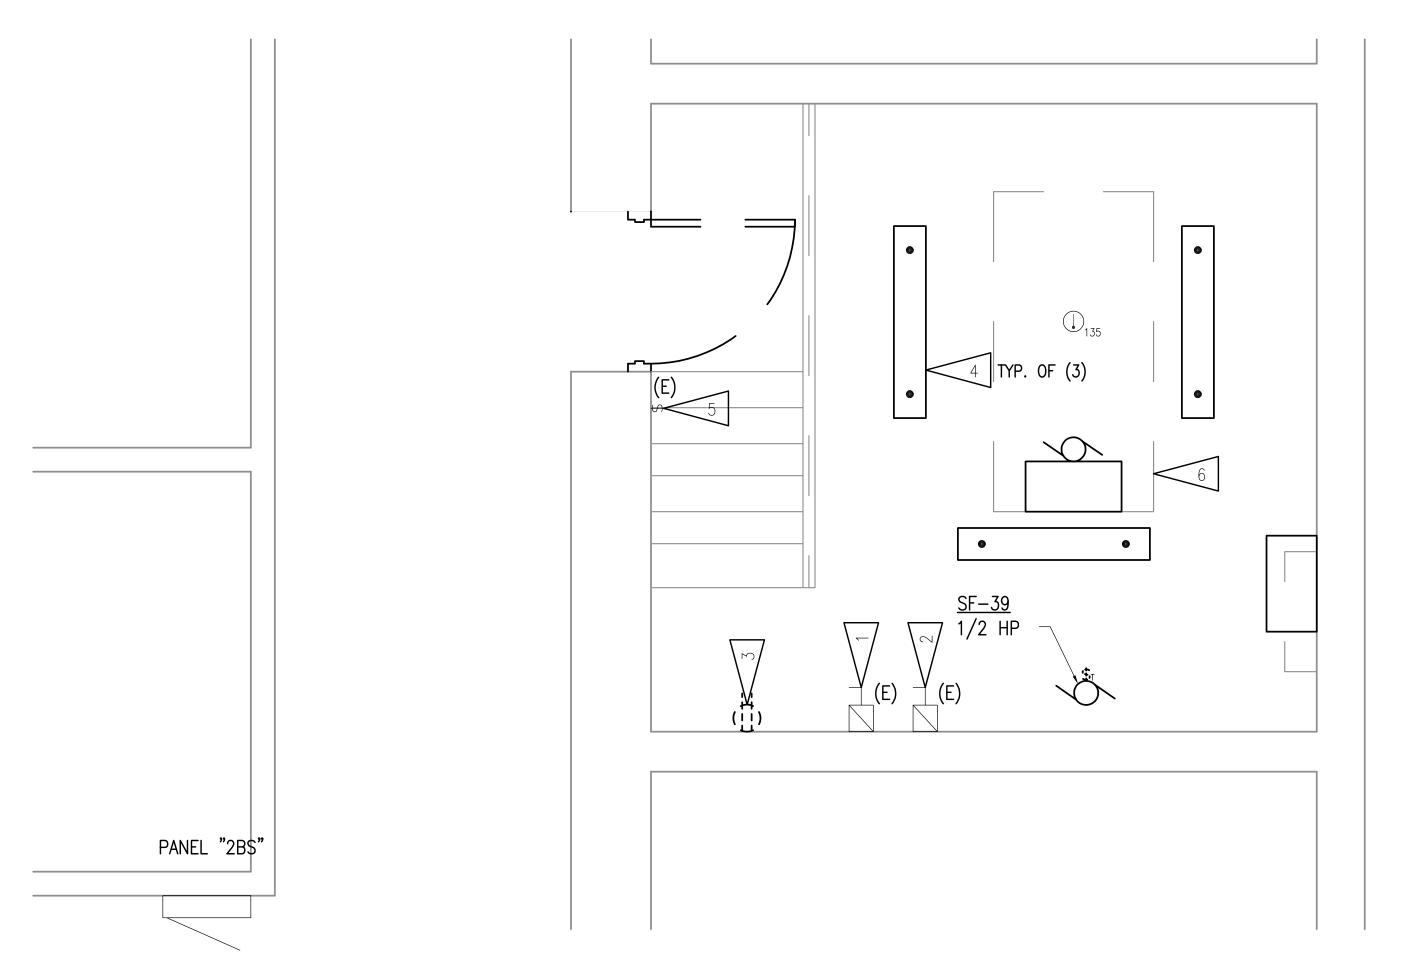

2 ELEVATOR MACHINE ROOM DEMOLITION PLAN


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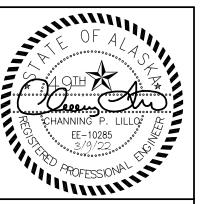
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- 1. THE INFORMATION SHOWN ON THIS DRAWING IS TAKEN FROM RECORD DRAWINGS AND A NON-DESTRUCTIVE WALK THROUGH OF THE FACILITY. THERE IS NO WARRANTY OR GUARANTEE AS TO THE ACCURACY OF THE INFORMATION SHOWN HERE-IN. THE CONTRACTOR SHALL FIELD VERIFY ALL ITEMS SCHEDULED FOR DEMOLITION PRIOR TO START OF WORK.
- 2. THE OWNER SHALL HAVE FIRST RIGHT OF REFUSAL ON ALL SALVAGEABLE MATERIALS. THE CONTRACTOR SHALL DELIVER SALVAGED MATERIALS TO A WAREHOUSE AS DIRECTED BY THE OWNER. THE CONTRACTOR SHALL DISPOSE OF, OFF SITE, ALL UNWANTED MATERIALS.
- 3. DASHED OR DOTTED LINES INDICATE ITEMS TO BE REMOVED. SOLID LINES INDICATE EXISTING ITEMS TO REMAIN.

SHEET NOTES

- 1. EXISTING SQUARE D 200A 3-PHASE FUSED DISCONNECT TO BE RE-USED FOR NEW ELEVATOR MOTOR CONTROLLER.
- 2. EXISTING SQUARE 'D' FUSED DISCONNECT FOR ELEVATOR CAB LIGHTS TO BE RE-USED WITH NEW ELEVATOR CAB LIGHTING CONTROLLER.
- 3. EXISTING RECEPTACLE TO BE DEMOLISHED AND REPLACED WITH NEW GFCI RECEPTACLE. SAVE JUNCTION BOX, CONDUIT AND CONDUCTORS FOR REUSE WITH NEW RECEPTACLE AT THE SAME LOCATION.
- 4. EXISTING LIGHT FIXTURE TO BE DEMOLISHED AND REPLACED WITH NEW FIXTURE. SAVE CONDUIT, JUNCTION BOXES AND CONDUCTORS FOR RE-USE WITH NEW FIXTURE AT THE SAME LOCATION.
- 5. EXISTING LIGHT SWITCH TO REMAIN AND BE RE-USED FOR CONTROL OF NEW LIGHT FIXTURES.
- 6. EXISTING ELEVATOR MOTOR AND CONTROLLER TO BE DEMOLISHED.



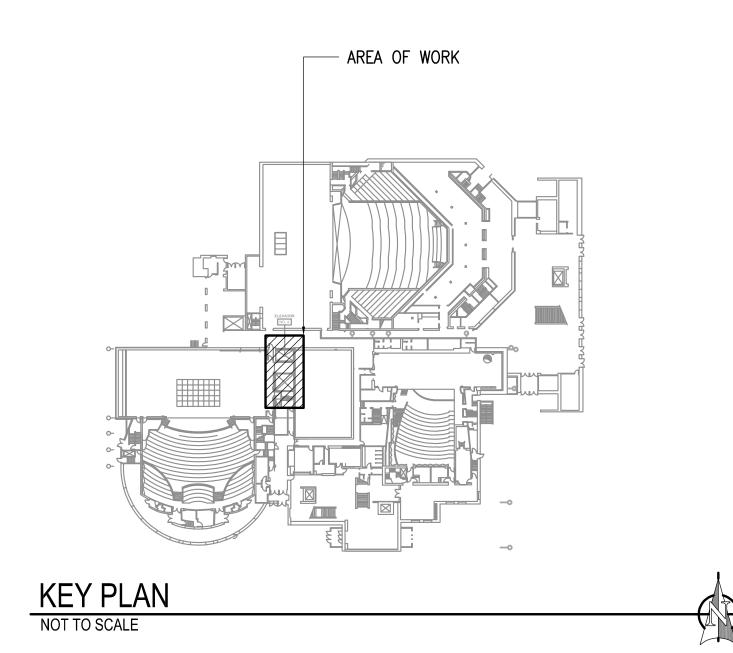

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Mechanical and Electrical Consultil Engineers
Anchorage, AK 99503

RFORMING ARTS CENTEVATOR MODERNIZAT

DATE: 3/9/22

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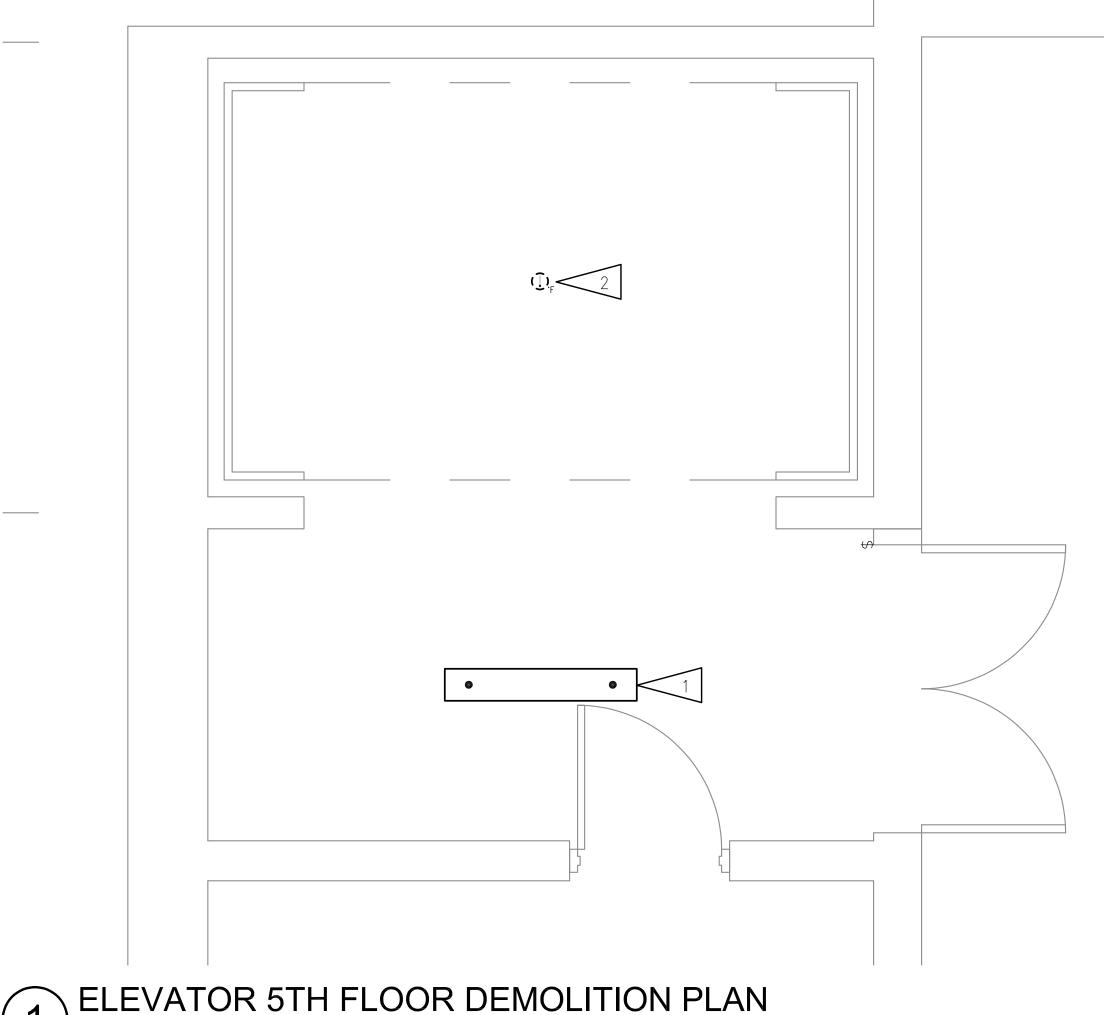
DRAWN: KWS,FWS
CHECKED: KWS,CPL

PROJECT: M1264

DRAWING TITLE:
ELEVATOR
DEMOLITION PLANS

REVISIONS:

SHEET NO:




1/2" = 1'-0"

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- 2. THE OWNER SHALL HAVE FIRST RIGHT OF REFUSAL ON ALL SALVAGEABLE MATERIALS. THE CONTRACTOR SHALL DELIVER SALVAGED MATERIALS TO A WAREHOUSE AS DIRECTED BY THE OWNER. THE CONTRACTOR SHALL DISPOSE OF, OFF SITE, ALL UNWANTED MATERIALS.
- 3. DASHED OR DOTTED LINES INDICATE ITEMS TO BE REMOVED. SOLID LINES INDICATE EXISTING ITEMS TO REMAIN.


SHEET NOTES

- 1. EXISTING LIGHT FIXTURE TO BE DEMOLISHED AND REPLACED WITH NEW FIXTURE. SAVE CONDUIT, JUNCTION BOXES AND CONDUCTORS FOR RE-USE WITH NEW FIXTURE AT THE SAME LOCATION.
- 2. HEAT DETECTOR AT TOP OF ELEVATOR SHAFT TO BE DEMOLISHED.

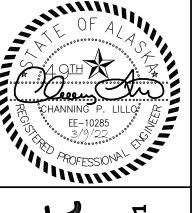

FORMING ARTS (ANCHORAGE

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KEY PLAN
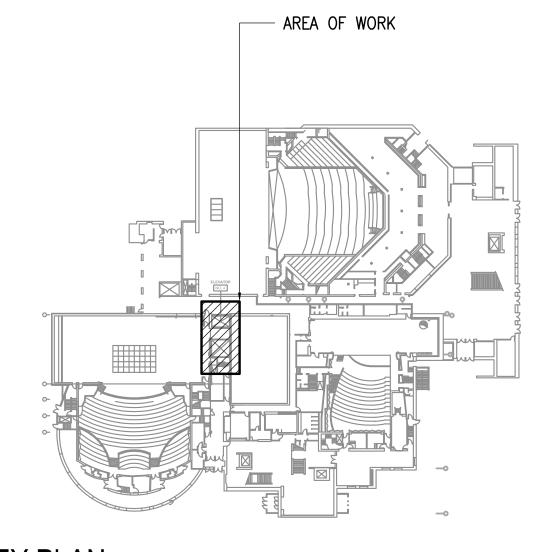
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DATE: 3/9/22 DRAWN: KWS,FWS


CHECKED: KWS,CPL

PROJECT: M1264 DRAWING TITLE:

ELEVATOR DEMOLITION PLANS

REVISIONS:

SHEET NO:

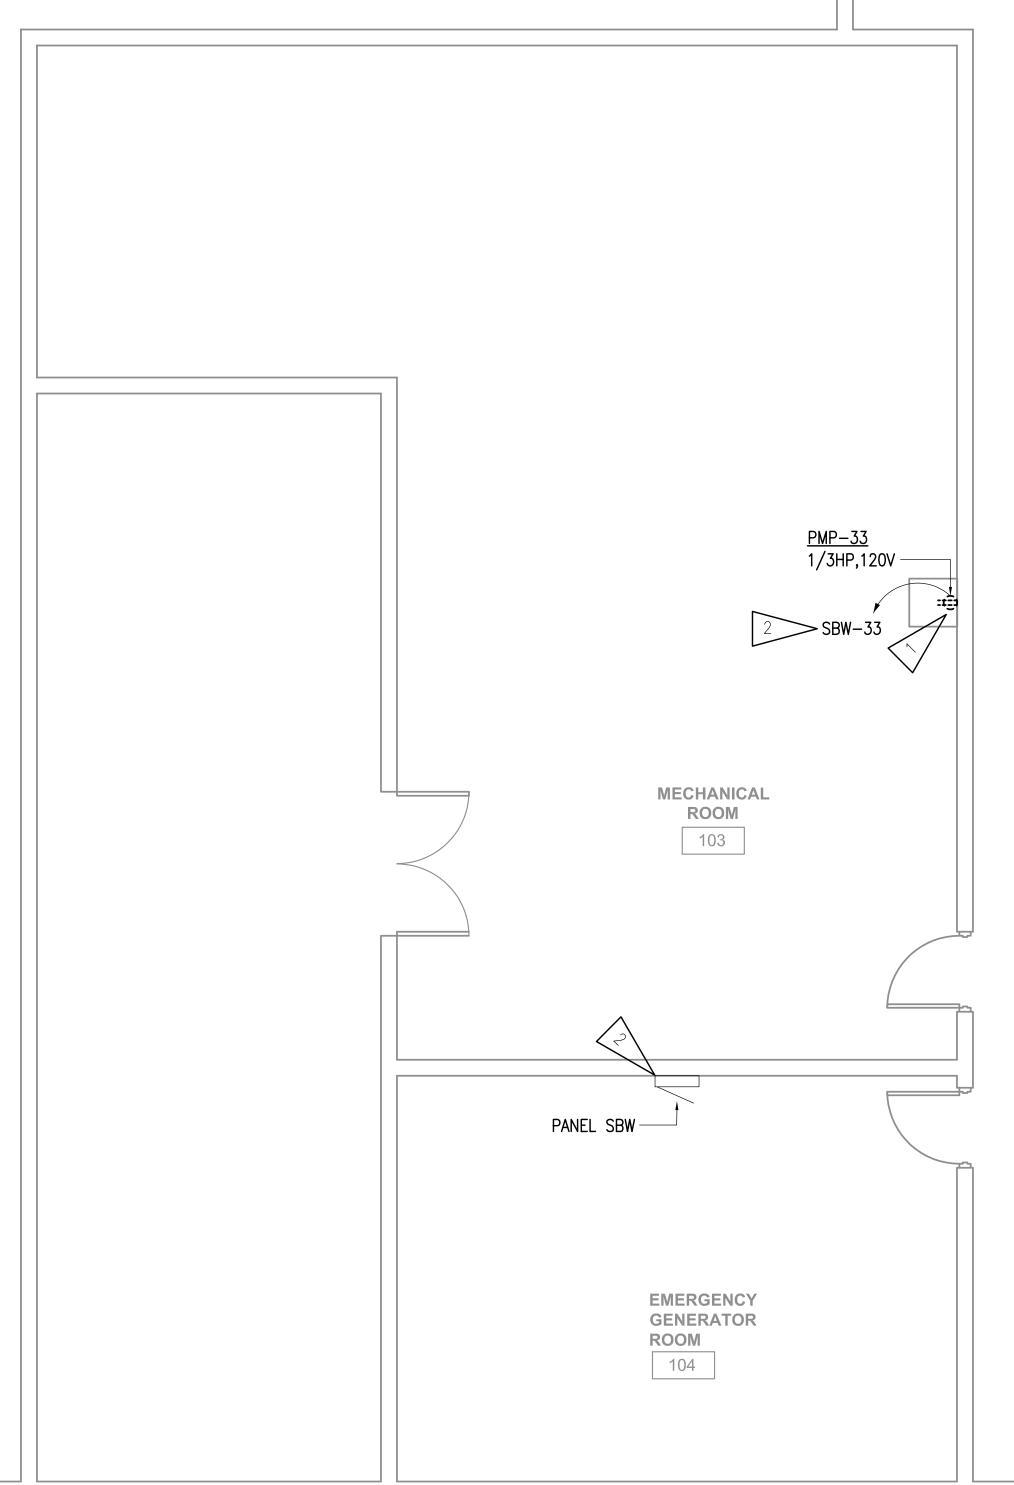

GENERAL NOTES:

- 1. THE INFORMATION SHOWN ON THIS DRAWING IS TAKEN FROM AS-BUILT DRAWINGS AND A NON-DESTRUCTIVE WALK THROUGH OF THE FACILITY. THERE IS NO WARRANTY OR GUARANTEE AS TO THE ACCURACY OF THE INFORMATION SHOWN HERE-IN. THE CONTRACTOR SHALL FIELD VERIFY ALL ITEMS SCHEDULED FOR DEMOLITION PRIOR TO START OF WORK.
- 2. THE OWNER SHALL HAVE FIRST RIGHT OF REFUSAL ON ALL SALVAGEABLE MATERIALS. THE CONTRACTOR SHALL DELIVER SALVAGED MATERIALS TO A WAREHOUSE AS DIRECTED BY THE OWNER. THE CONTRACTOR SHALL DISPOSE OF, OFF SITE, ALL UNWANTED MATERIALS.
- 3. DASHED OR DOTTED LINES INDICATE ITEMS TO BE REMOVED. SOLID LINES INDICATE EXISTING ITEMS TO REMAIN.

SHEET NOTES

KEY PLAN

NOT TO SCALE

1. DEMOLISH NEMA 5-15 RECEPTACLE. SAVE JUNCTION BOX AND CIRCUIT FOR REUSE WITH NEW 5-20 RECEPTACLE IN SAME LOCATION.

AREA OF WORK

2. 15A/1P CIRCUIT BREAKER TO BE REPLACED WITH NEW 20A/1P. TURN BREAKER OVER TO OWNER.



PER ELE

DATE: 3/9/22

DRAWN: KWS,FWS CHECKED: KWS,CPL


PROJECT: M1264

DRAWING TITLE: ELEVATOR DEMOLITION PLANS


REVISIONS:


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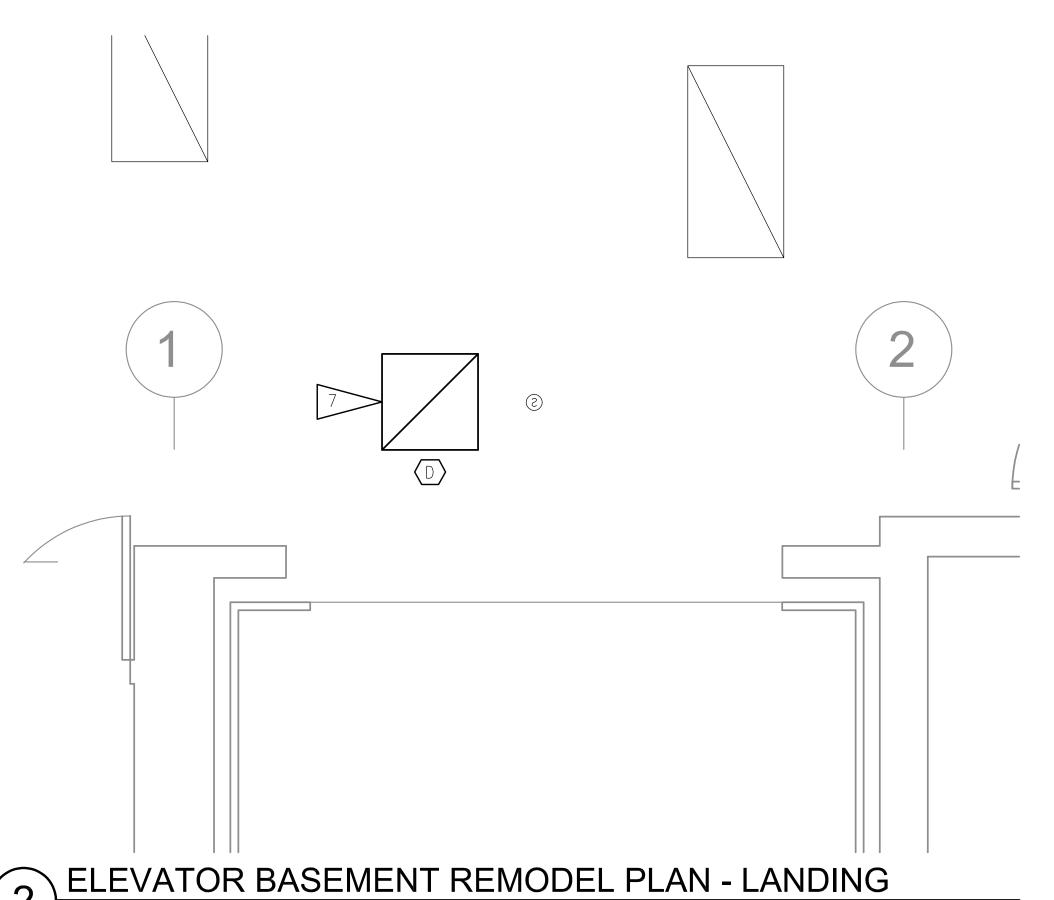
E103

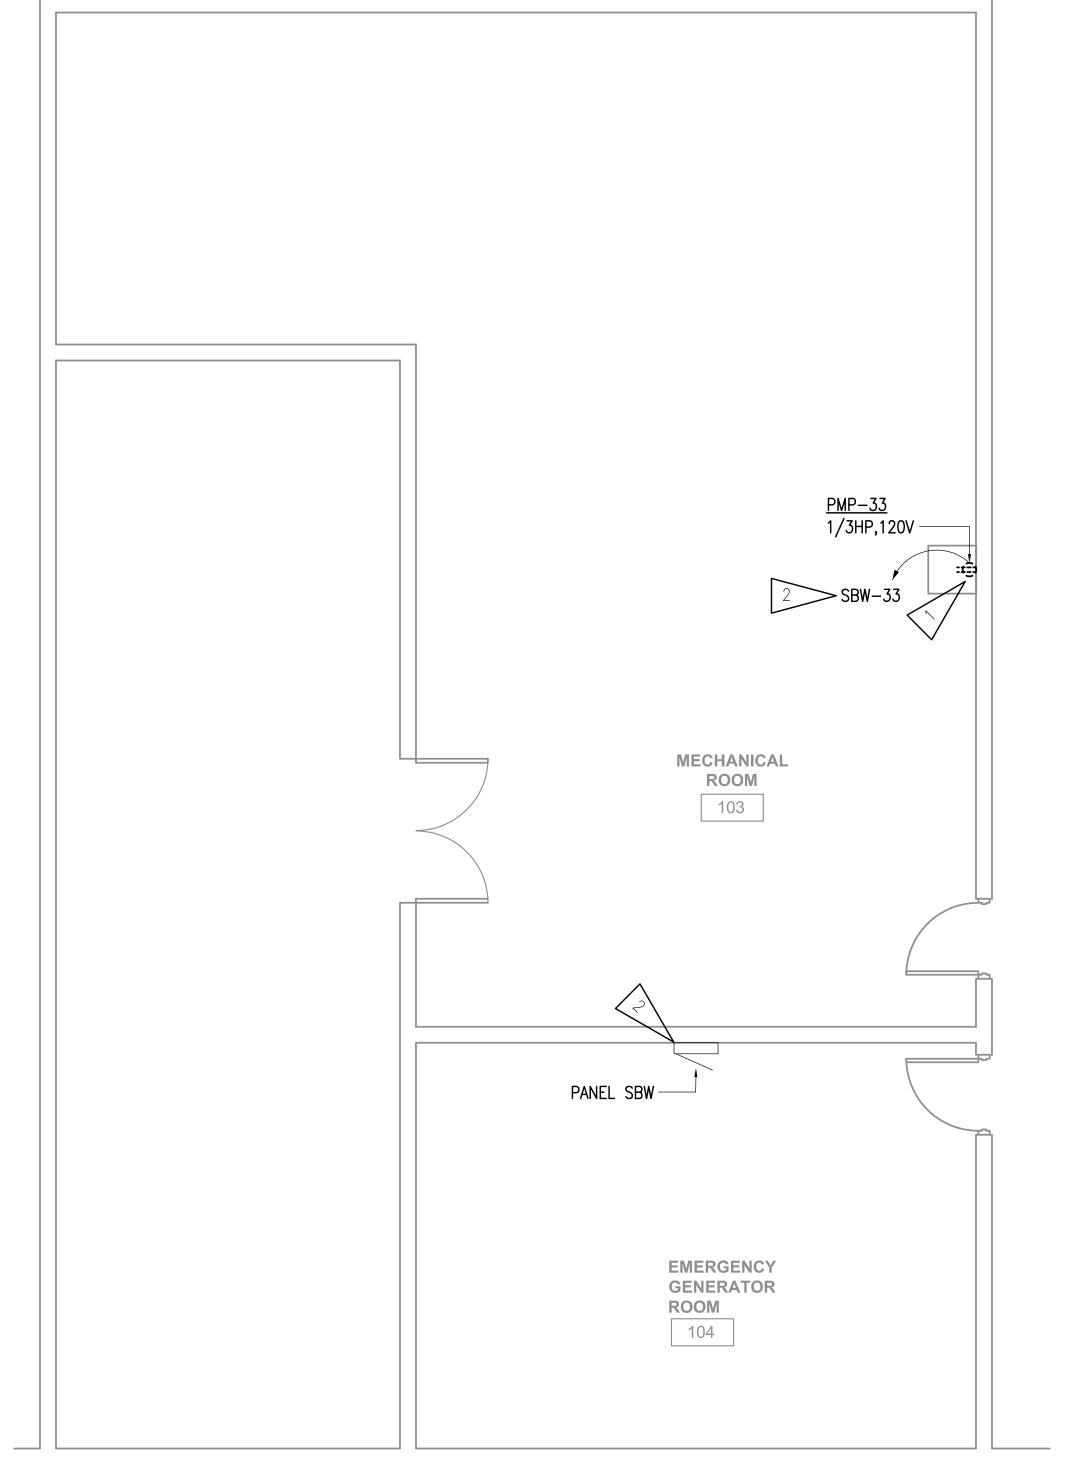


1) MECHANICAL ROOM 103 DEMOLITION PLAN



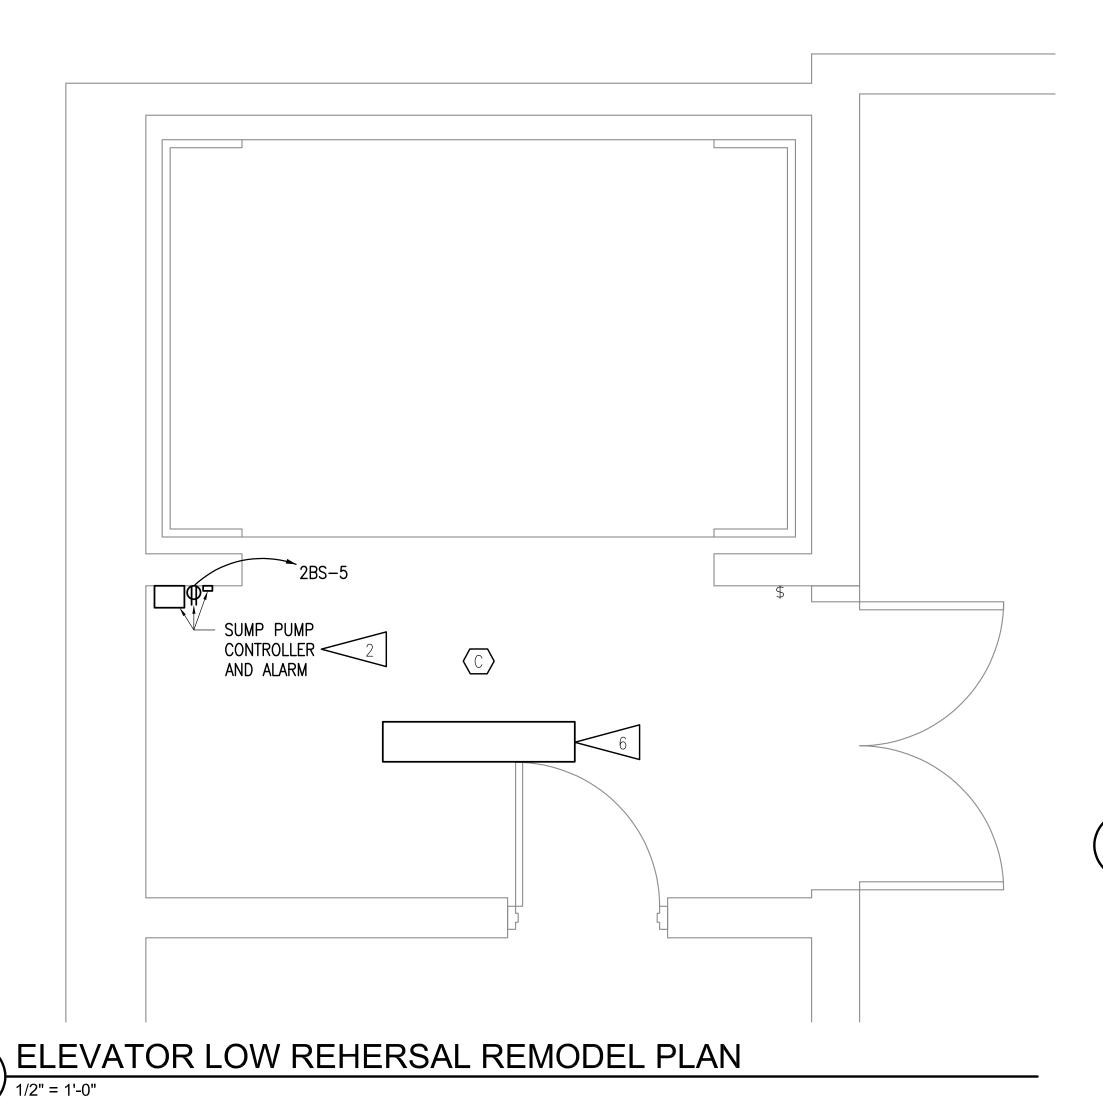


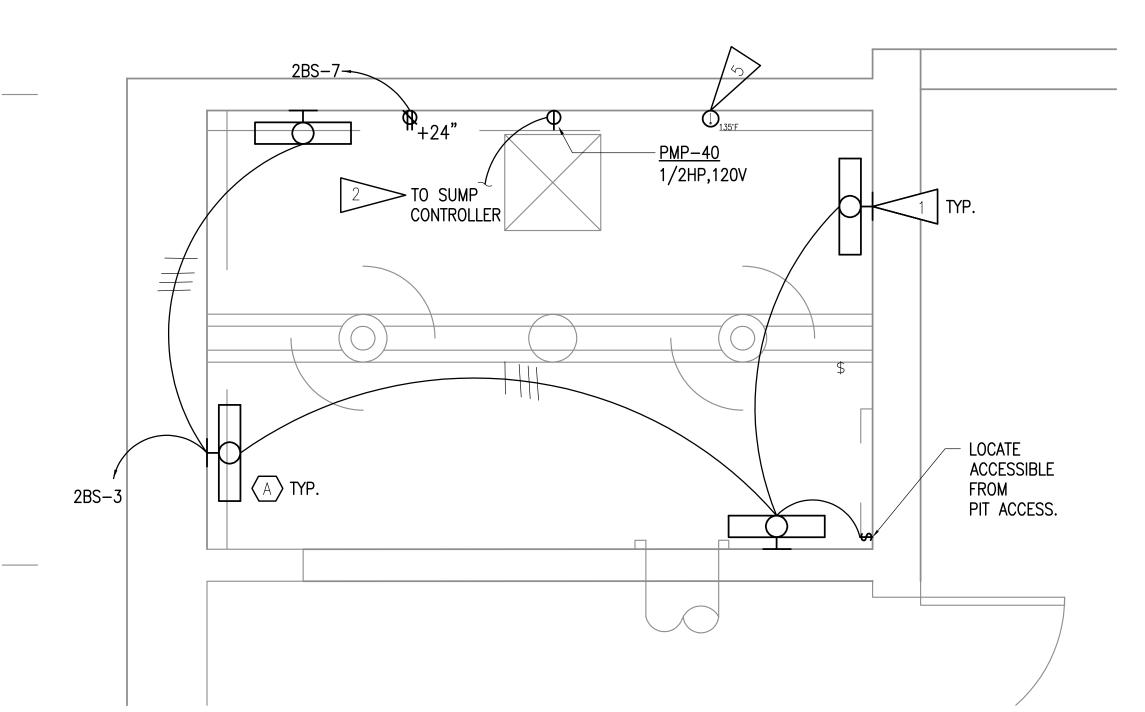

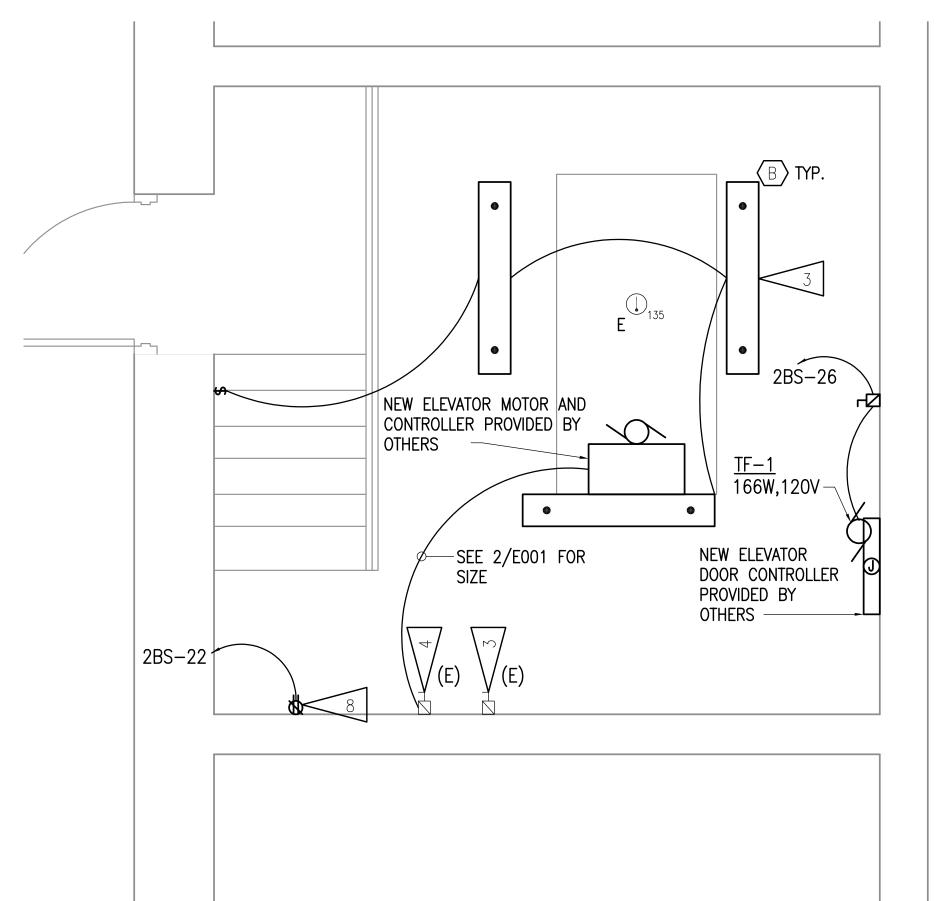

SHEET NOTES

- FIELD LOCATE FIXTURES TO AVOID CONFLICTS WITH ELEVATOR. FIXTURES MAY BE MOUNTED VERTICALLY.
- 2. SEE 1/E003 FOR SUMP CONTROLLER AND SUMP PUMP INSTALLATION DETAIL.
- 3. EXISTING DISCONNECT FOR ELEVATOR CAB LIGHTING AND VENTILATION TO BE RE-USED. PROVIDE NECESSARY CONNECTIONS TO ELEVATOR CONTROLLER AS PER MANUFACTURERS' INSTRUCTIONS. CONTRACTOR SHALL REPLACE EXISTING RK 1 CLASS 30A FUSE WITH 15A FUSE RATED FOR AND LISTED FOR USE IN EXISTING DISCONNECT.
- 4. EXISTING DISCONNECT FOR ELEVATOR MOTOR TO BE RE-USED. PROVIDE NECESSARY CONNECTIONS TO ELEVATOR CONTROLLER AS PER MANUFACTURERS' INSTRUCTIONS. CONTRACTOR SHALL VERIFY EXISTING CLASS RF5 125A FUSES AND REPLACE WITH 100A FUSES RATED FOR AND LISTED FOR USE IN EXISTING DISCONNECT.
- 5. PROVIDE HEAT DETECTOR PROTECTOWIRE #CTM-530 OR EQUIVALENT AND PROVIDE CONNECTION TO EXISTING FACP. PROVIDE NEMA 1 ENCLOSURE AND INSTALL TEST STATION IN ACCESSIBLE LOCATION OUTSIDE ELEVATOR PIT.
- 6. CONTRACTOR SHALL INSTALL NEW FIXTURE IN PLACE OF DEMOLISHED FIXTURE AND CONNECT TO EXISTING PANEL "WWB" LOCAL LIGHTING CIRCUIT AND CONTROLS, RE-USING EXISTING CONDUIT AND CONDUCTORS WHILE EXTENDING OR REPLACING AS NECESSARY FOR A COMPLETE ELECTRICAL SYSTEM
- 7. CONTRACTOR SHALL INSTALL NEW FIXTURE AS SHOWN AND CONNECT TO EXISTING PANEL "WWB" LOCAL LIGHTING CIRCUIT AND CONTROLS.
- 8. PROVIDE NEW GFCI RECEPTACLE AS SHOWN.

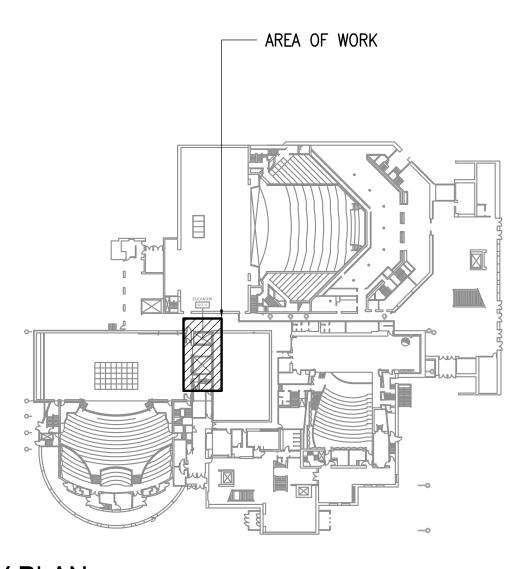

KEY PLAN

NOT TO SCALE

ROOM



Mechanical and
Electrical Consultin
Engineers
670 West Fireweed Lane, Suite 200
Anchorage, AK 99503
(907)276-0521
Corporate No.: AECC542

FORMING ARTS CENTER

VATOR MODERNIZATION

W 6TH AVE ANCHORAGE, ALASKA 99501

DATE: 3/9/22

PERF ELEV

DRAWN: KWS,FWS
CHECKED: KWS,CPL

PROJECT: M1264


DRAWING TITLE:
ELEVATOR
REMODEL PLANS


REVISIONS:

SHEET NO:

E201

ELEVATOR BASEMENT REMODEL PLAN - MACHINE ROOM

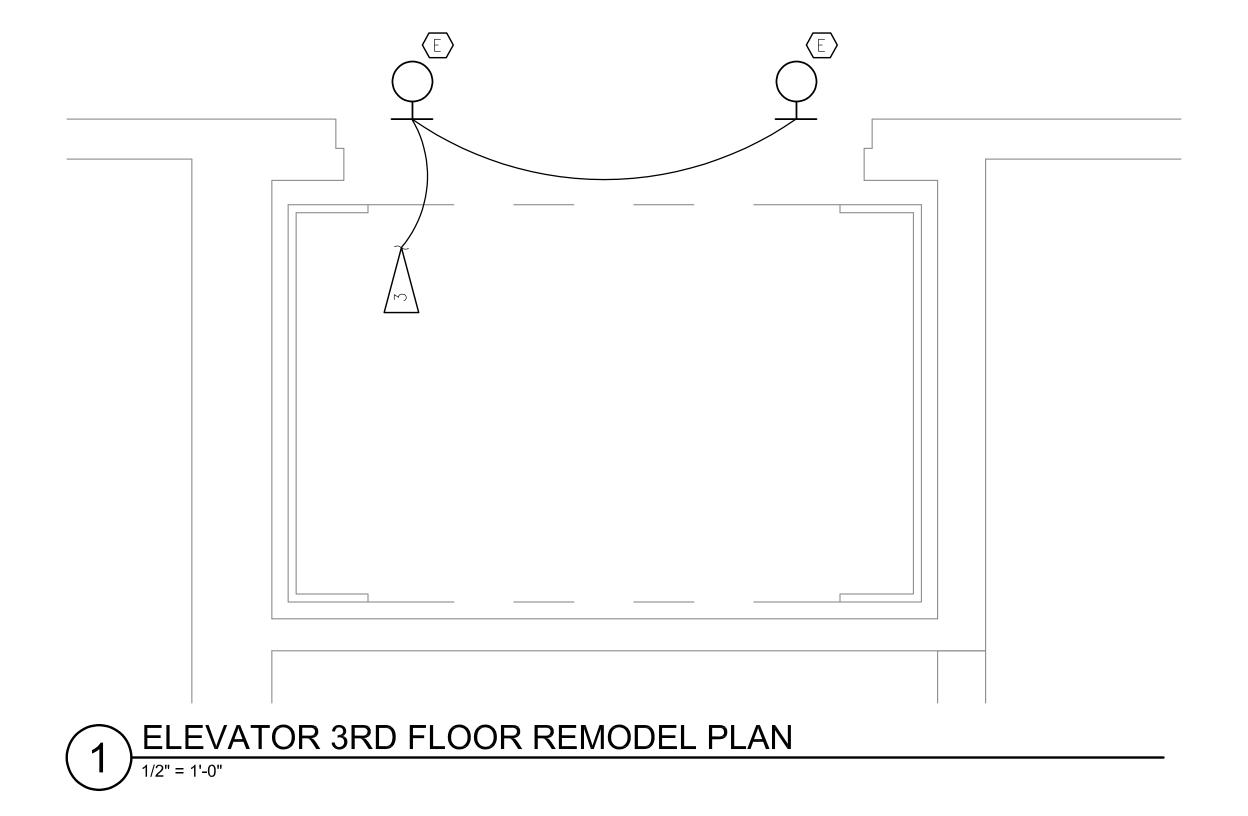

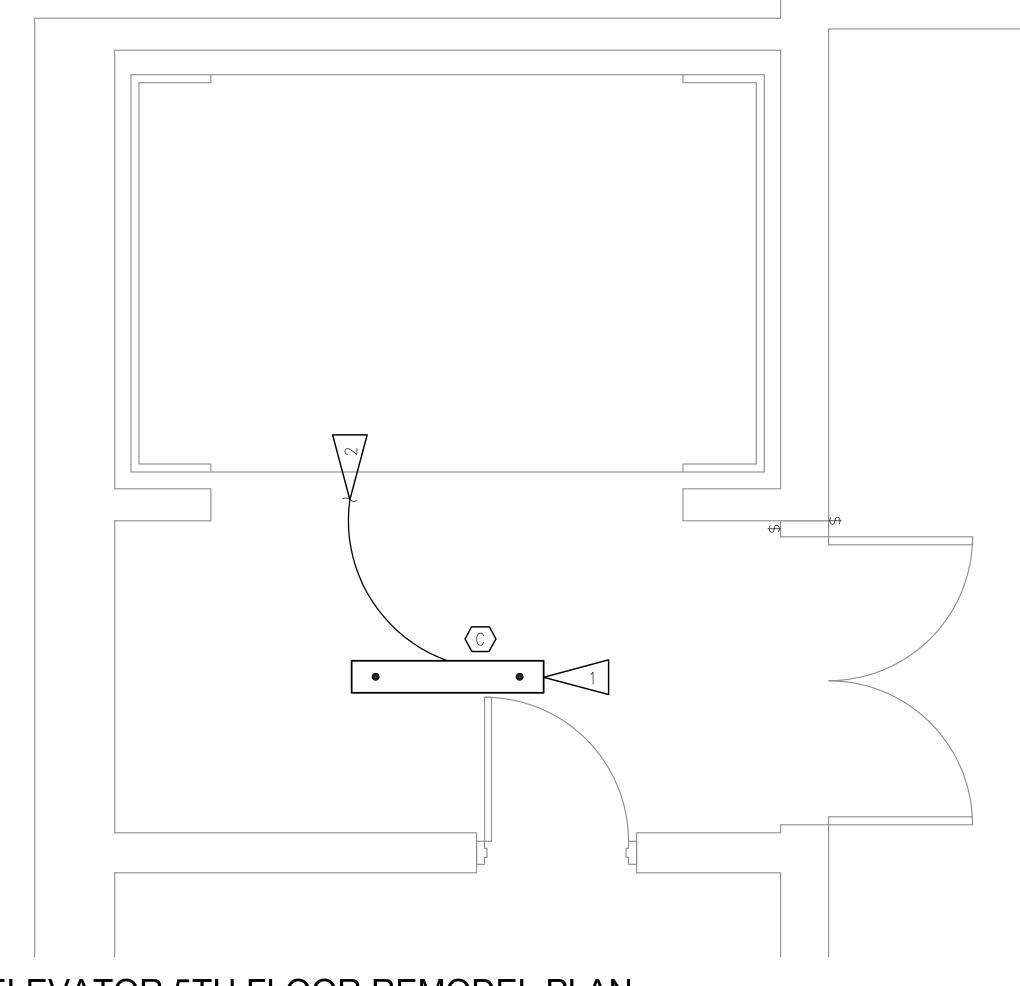


2 ELEVATOR 5TH FLOOR REMODEL PLAN

1/2" = 1'-0"


SHEET NOTES

- CONTRACTOR SHALL INSTALL NEW FIXTURE IN PLACE OF DEMOLISHED FIXTURE AND CONNECT TO EXISTING LOCAL LIGHTING CIRCUIT AND CONTROLS, RE-USING EXISTING CONDUIT AND CONDUCTORS WHILE EXTENDING OR REPLACING AS NECESSARY FOR A COMPLETE ELECTRICAL SYSTEM.
- 2. PROVIDE CONDUCTOR AND CONDUIT DOWN TO 3RD FLOOR (MEZZANINE) FOR NEW LIGHT FIXTURES.
- 3. CONTRACTOR SHALL INSTALL NEW FIXTURES AS SHOWN AND CONNECT TO EXISTING LOCAL LIGHTING CIRCUIT ON PANEL "LFR". PATCH/REPAIR DRY WALL AND MATCH PAINT AS REQUIRED FOR CONCEALED CONDUIT AND BOXES.

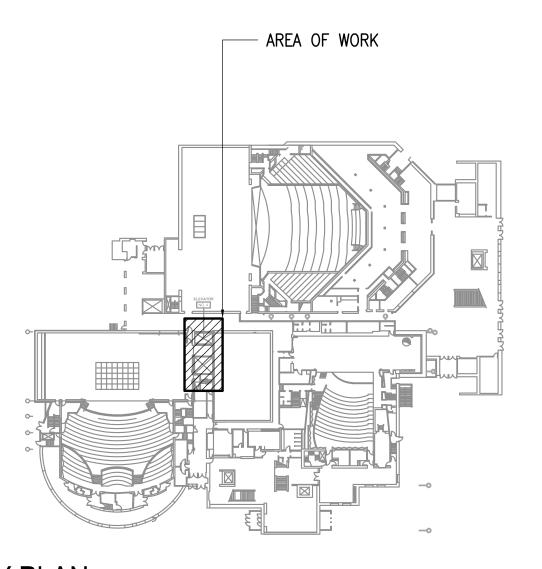

KEY PLAN

NOT TO SCALE

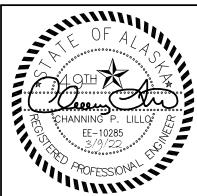

FORMING ARTS CE ANCHORAGE

DATE: 3/9/22

DRAWN: KWS,FWS CHECKED: KWS,CPL


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PROJECT: M1264

DRAWING TITLE: ELEVATOR REMODEL PLANS

REVISIONS:

SHEET NO:

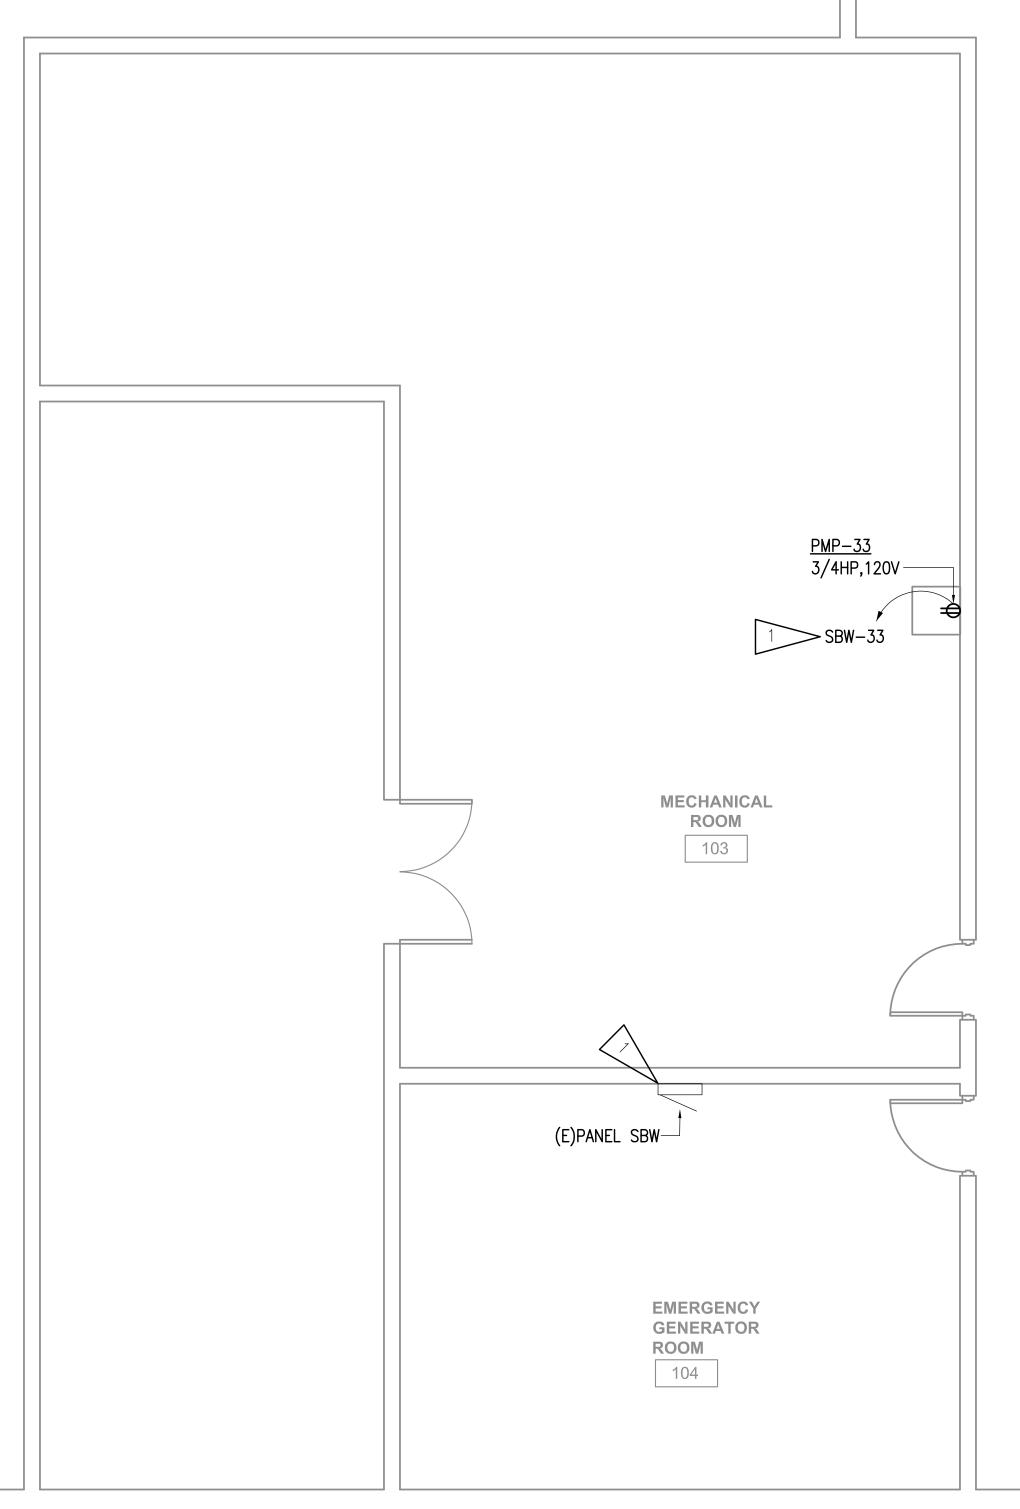

MECHANICAL ROOM 103 DEMOLITION PLAN

1/4" = 1'-0"


SHEET NOTES

1. INSTALL NEW 20A/1P CIRCUIT BREAKER IN SPACE SHOWN. THE EXISTING PANEL IS A SQUARE—D TYPE NQOD, 208Y/120V, 3Ø, 4W. THE NEW CIRCUIT BREAKER SHALL BE COMPATIBLE WITH AND LISTED FOR USE IN THE EXISTING PANEL BOARD AND SHALL HAVE A MINIMUM SHORT CIRCUIT AIC RATING TO MATCH THE LOWEST RATED EXISTING DEVICE IN THE PANEL.

AREA OF WORK

KEY PLAN

NOT TO SCALE

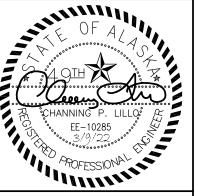

PER! ELE

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DRAWN: KWS,FWS CHECKED: KWS,CPL

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DRAWING TITLE: ELEVATOR REMODEL PLANS

REVISIONS:

SHEET NO:

