# MUNICIPALITY OF ANCHORAGE LOUSSAC LIBRARY TRAINING ROOM

3600 DENALI STREET ANCHORAGE AK 99503

**OWNER** 

## MUNICIPALITY OF ANCHORAGE

3640 EAST TUDOR ROAD, WAREHOUSE NO. 1 ANCHORAGE, ALASKA 99507

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## **ARCHITECT**

## BURKHART CROFT ARCHITECTS, LLC

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**VICINITY MAP** 

PROJECT LOACTION

## **ABBREVIATIONS**

L @ C O #	angle at centerline diameter pound or number	CCCC
AB ACT ADD ADD'L ADH ADJ AFF AP APPROX ARCH	anchor bolt acoustical tile additive additional adhesive adjustable above finished floor access panel	
BD BLDG BLK BM BO	board building block or blocking beam bottom of	D D E E

ABBREVIA	ATIONS INDICATED MAY	NOT ALL	BE USED IN THESE CONST	RUCTION	I DC
& L @ C O #	and angle at centerline diameter pound or number	CER CLG CO CLO CMU COL	ceramic ceiling carbon monoxide closet concrete masonry unit column	EQ EQUIP EXT EXIST EXST'G (E)	equent ext exi exi exi
AB ACT ADD	anchor bolt acoustical tile additive	CONST CONT CPT CT	construction continuous carpet ceramic tile	FA FCB FCO	fire fib flo
ADD'L ADH ADJ AFF AP APPROX ARCH	additional adhesive adjustable above finished floor access panel approximate architectural	DEMO DET DF DIAM DIM DISP DN	demolition detail drinking fountain diameter dimension dispenser down	FCTY FD FDN FE FEC FHC FIN FL	faction for fire fire fire fire fire fire fire fir
BD BLDG BLK BM	board building block or blocking beam	DS DWG EA	downspout drawing each	FOC FOF	fa fa fa
BO CEM	bottom of cement	ELEC EPS	electrical expanded polystyrene	FOS FRP FURN	fa fib fu

RUCTION	DOCUMENTS. SEE ME	CHANICA
EQ EQUIP EXT EXIST EXST'G (E)	equal equipment exterior existing existing existing	FURR FV GA GALV GB GL
FA FCB FCO	fire alarm fiber cement board floor clean out	GLBM GWB
FCTY FD FDN FE FEC	factory finish floor drain foundation fire extinguisher fire extinguisher cabinet	HDW HM HORIZ HT HVAC
FHC FIN	fire hose cabinet finish	HWH
FIN FL FO	floor face of	INSUL INT
FOC	face of concrete	JT
FOF FOS	face of finish face of stud	LAV
FRP FURN	fiberglass reinf. panel furnace	MAX MECH

HANICAL	& ELECTRICAL FOR	ABB
URR V	furring field verify	ME MF
GA GALV GB GL GLBM GWB	gauge or gage galvanized grab bar glass or glazing glu-lam beam gypsum wall board	MF MIN MIS MR MT MT
IDW IM IORIZ IT IVAC	hardware hollow metal horizontal height heating, ventilating, and air conditioning hot water heater	(N) NIC NC NC NT OC OC
VA 1 XA1	insulation interior joint lavatory maximum mechanical	O.F O.F OS PL P. PL

BBREVIA MET MFD MFR MH MIN MISC MR MTD MTL (N) NIC NOM NTS OC O.F.O.I. OSB PL P. LAM PLYWD PNT	metal manufactured manufacturer manhole minimum, minute miscellaneous mop rack mounted material new not in contract number nominal not to scale on center overflow drain owner furnished contractor owner furnished owner ins oriented strand board plate plastic laminate plywood paint	PT PTD PTD/R  PTR QT RD REQ REQM'TS RM RO R&S SA-VR SD SECT SHR r installec

S.		
r'S	pressure treated paper towel dispenser paper towel dispenser / receptacle paper towel receptacle quarry tile roof drain required requirements room rough opening rod and shelf	
	self-adhered vapor retarder soap dispenser section shower similar structural insulated panel sanitary napkin dispenser sanitary napkin receptacle specification square storage	\\\\\\\\\\\\\\\\\\\\\\\\\\\\\\\\\\\\\\

STRL STRUCT SUSP S.V.	structural structural suspended sheet vinyl
T&G TC	tongue and groove trash chute
T.O. TPD TYP	top of toilet paper dispense typical
U.N.O. UH	unless noted otherw unit heater
VAR VCT VERT VR VTR	varies vinyl composition tile vertical vapor retarder vent through roof
W	washer

with


wood


water heater

wainscot

water resistant

# **SYMBOLS**

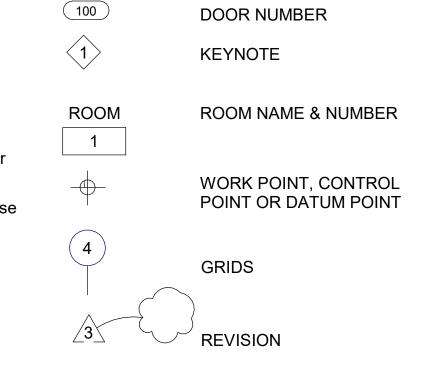

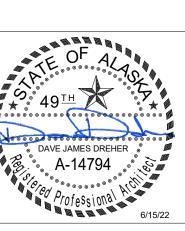

IBR/ ROC

DATE: 6/15/22 DRAWN: HLC

CHECKED: DJD


PROJECT: 1718.74 DRAWING TITLE:

PROJECT DATA


**REVISIONS:** 

SHEET NO:

G101

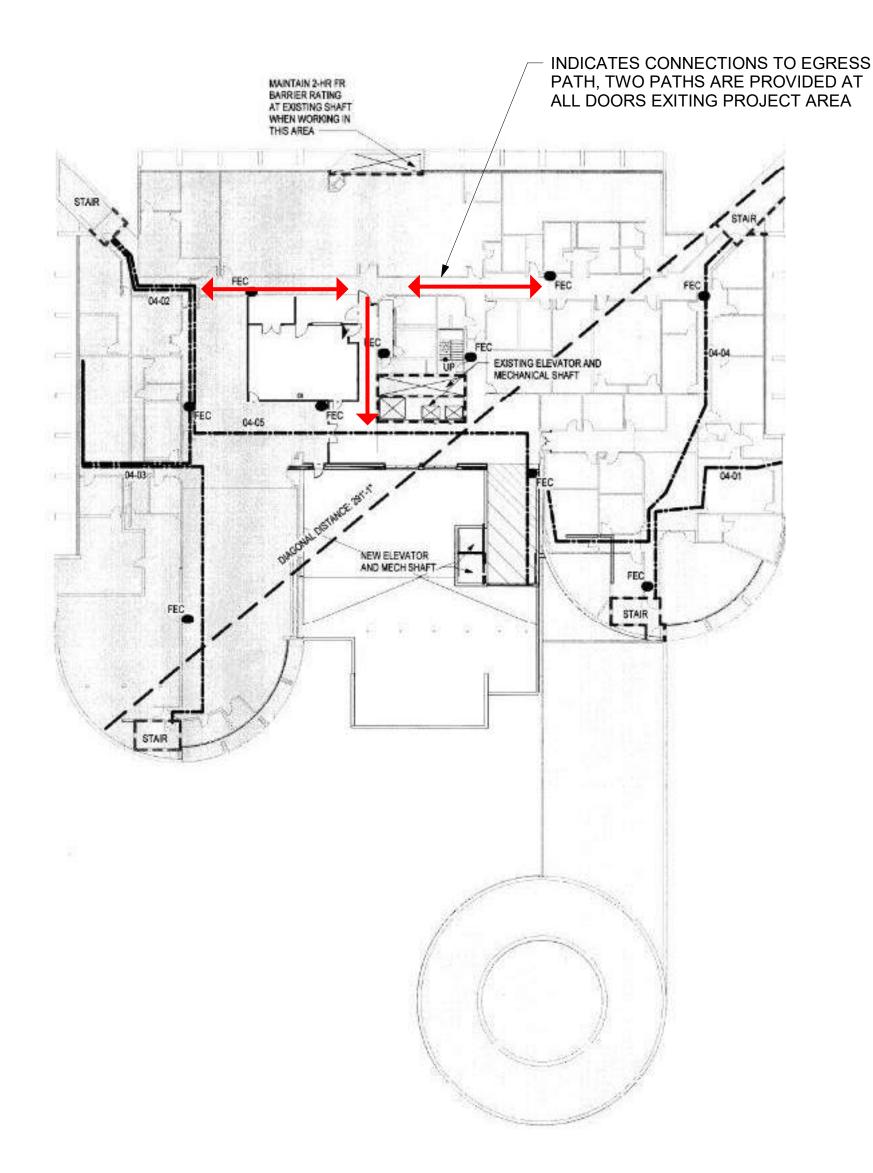

**EXISTING EGRESS PATH - 2015 PROJECT** 

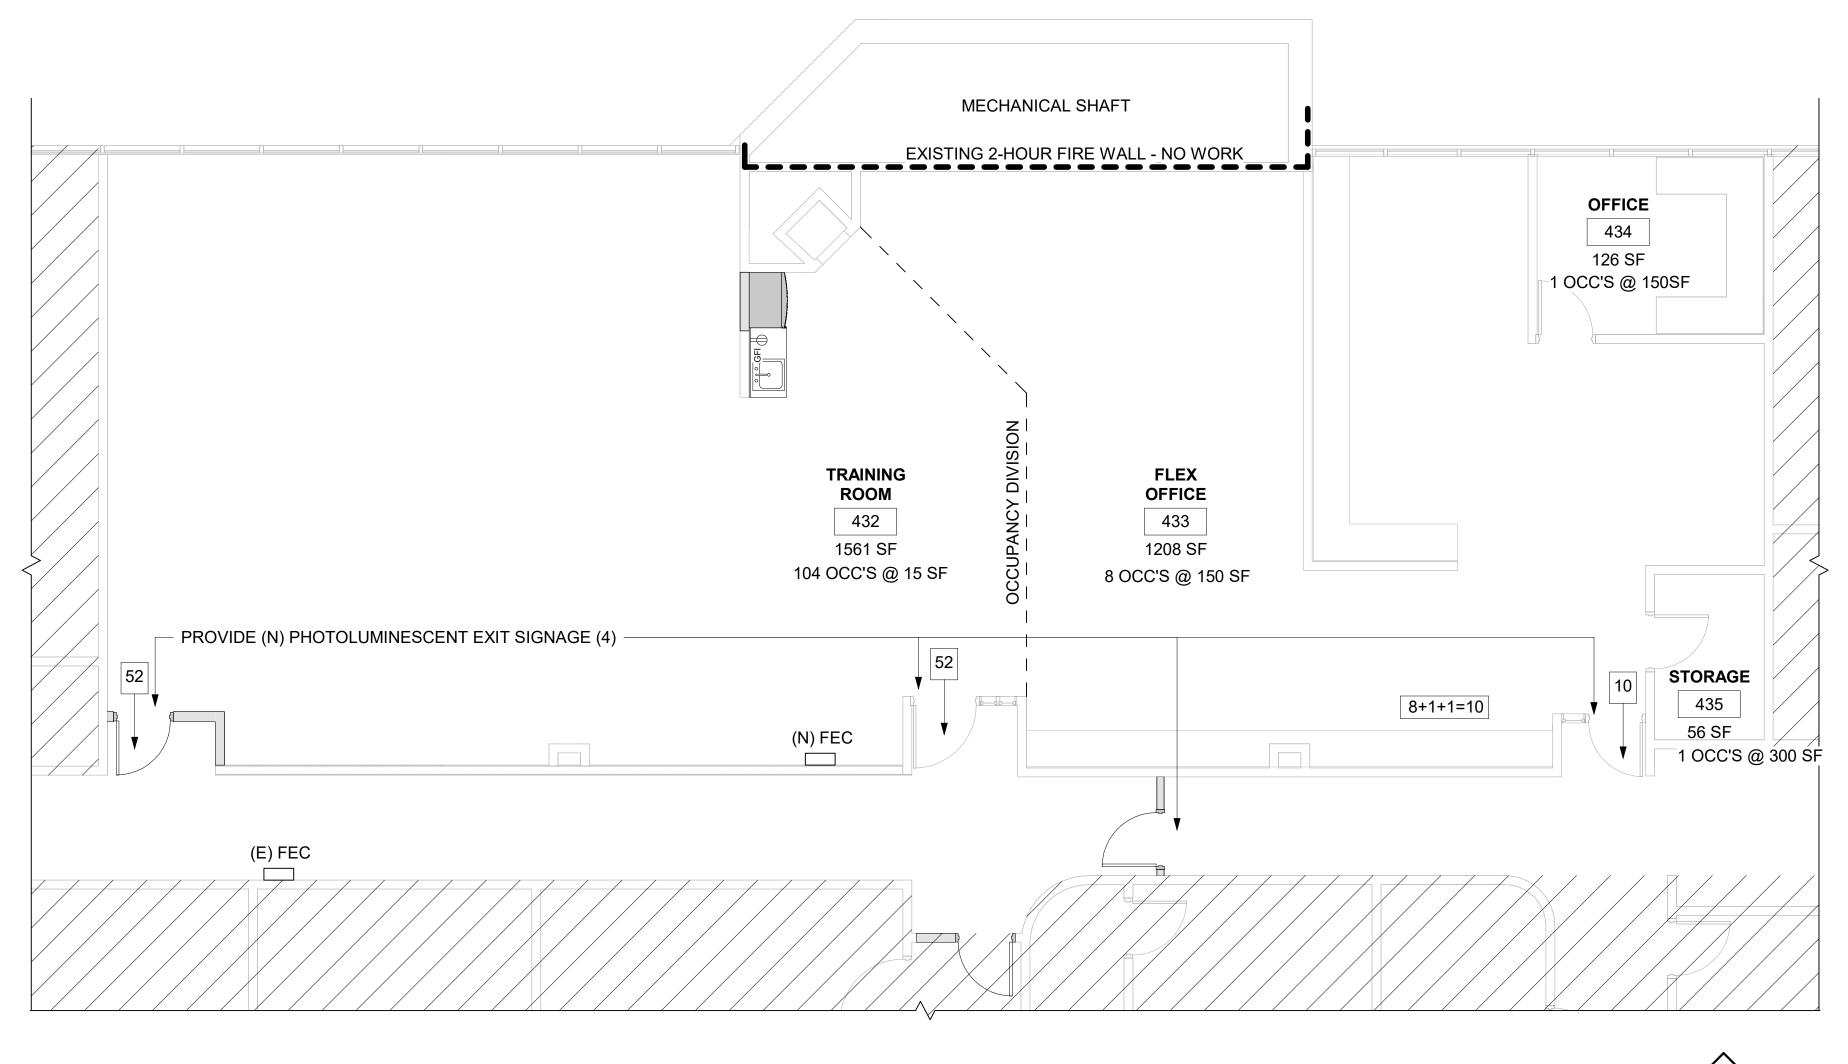

# 1 CODE PLAN

Scale: 3/16" = 1'-0"

### PROJECT DATA & BUILDING CODE ANALYSIS - IEBC LEVEL 3 ALTERATION:

**BUILDING DATA:** 

CONSTRUCTION CLASSIFICATION: BUILT IN 1986 - CONSTRUCTED UNDER THE 1979 UNIFORM BUILDING CODE (UBC) AS A "TYPE I"

#### THE BUILDING IS FULLY SPRINKLERED

APPLICABLE BUILDING CODES: 2018 INTERNATIONAL BUILDING CODE

2018 INTERNATIONAL EXISTING BUILDING CODE
2018 UNIFORM PLUMBING CODE

2018 INTERNATIONAL FIRE CODE 2017 NATIONAL ELECTRICAL CODE

2018 INTERNATIONAL MECHANICAL CODE 2018 UNIFORM PLUMBING C 2016 ANSI/ASME A17.1 SAFETY CODE FOR ELEVATORS AND ESCALATORS

PROJECT SCOPE INCLUDES CONVERTING AN AREA OF THE FOURHT FLOOR TO HOUSE A TRAINING FUNCTION AND FLEXIABLE OFFICE AREAS. THE EXISTING SPACE WAS USED AS A TRAINING ROOM.

THIS WORK IS BEING DONE AS A LEVEL II ALTERATION PER THE 2018 IEBC. PROJECT SCOPE INCLUDES CONVERTING AN AREA OF THE FOURTH FLOOR TO HOUSE A TRAINING FUNCTION AND FLEXIABLE OFFICE AREAS. THE EXISTING SPACE WAS USED AS A TRAINING ROOM. A PORTION OF THE AREA WILL REMAIN A "BUSINESS" OCCUPANCY, WHILE THE REMAINDER IS BEING CONVERTED INTO AN "ASSEMBLY" OCCUPANCY. MODIFICATIONS ARE BEING MADE TO THE EXISTING SPACE TO ACCOMODATE NEW OCCUPANCY AND EXITING.

PER RECORD DOCUMENTS, EXITING OCCUPANT LOAD OF THE FOURTH FLOOR IS 345. THIS PROJECT WOULD INCREASE OCCUPANT LOAD BY 90, OR 435 TOTAL. FOUR EXITS ARE EXISTING, SERVING THE FOURTH FLOOR.

#### **2018 INTERNATIONAL EXISTING BUILDING CODE:**

#### 805.4.4 PANIC HARDWARE:

IN ANY WORK AREA, AND IN THE EGRESS PATH FROM ANY WORK AREA TO THE EXIT DISCHARGE, IN BUILDINGS OR PORTIONS THEREOF OF GROUP A ASSEMBLY OCCUPANCIES WITH AN OCCUPANT LOAD GREATER THAN 100, ALL REQUIRED EXIT DOORS EQUIPPED WITH LATCHING DEVICES SHALL BE EQUIPPED WITH APPROVED PANIC HARDWARE.



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C LIBRARY TRAINING ROOM

DATE: 6/15/22

DRAWN: DJD

CHECKED: DJD
PROJECT: 1718.74

DRAWING TITLE: CODE STUDY

REVISIONS:

SHEET NO:

G102

#### SECTION 06 40 23 - INTERIOR ARCHITECTURAL WOODWORK

#### PRODUCTS, GENERAL

- General: Provide materials that comply with requirements of AWI's quality standard for each type of woodwork and quality grade specified, unless otherwise indicated.
- Wood Products: Comply with the following:
  - Hardboard: AHA A135.4.
  - Medium-Density Fiberboard: ANSI A208.2, Grade MD, made with binder containing no urea formaldehyde.
  - Particleboard: ANSI A208.1, Grade M-2 M-2-Exterior Glue.
  - Softwood Plywood: DOC PS 1, Medium Density Overlay.
  - Veneer-Faced Panel Products (Hardwood Plywood): HPVA HP-1, made with adhesive containing no urea formaldehyde.
- Thermoset Decorative Panels: Particleboard or medium-density fiberboard finished with thermally fused, melamine-impregnated decorative paper complying with LMA SAT-1.
- Provide PVC banding complying with LMA EDG-1 on components with exposed or semiexposed edges
- High-Pressure Decorative Laminate: NEMA LD 3, grades as indicated or, if not indicated, as required by woodwork quality standard.
- 1. Available Manufacturers: Subject to compliance with requirements, manufacturers offering high-pressure decorative laminates that may be incorporated into the Work include, but are not limited to, the following: a. Formica Corporation.
- Solid-Surfacing Material: Homogeneous solid sheets of filled plastic resin complying with ISSFA-2.
  - 1. Available Manufacturers: Subject to compliance with requirements. manufacturers offering products that may be incorporated into the Work include, but are not limited to, the following: Corian
  - 2. Colors and Patterns: As shown on Drawings.

#### CABINET HARDWARE AND ACCESSORIES

- General: Provide cabinet hardware and accessory materials associated with architectural cabinets. Provide as follows or equivalent in finish, material, strength, fabrication, and operation.
- Butt Hinges: 2-3/4-inch, 5-knuckle steel hinges made from 0.095-inch- thick metal, and as follows:
- Fasten with 4 screws to end panel and 5 screws to door panel.
- Door opening of 270 degrees.
- Satin chrome finish standard.
- Product RPC # 374
- Semiconcealed Hinges for Overlay Doors: BHMA A156.9, B01521.
- Pulls: Stanley no. 4483-1/2/US10B.
- Catches: Stanley No. SP46.
- Adjustable Shelf Standards and Supports: BHMA A156.9, B04071; with shelf rests,
- Shelf Rests: BHMA A156.9, B04013; metal, two-pin type with shelf hold-down clip. Drawer Slides: BHMA A156.9, B05091.
- Heavy Duty (Grade 1HD-100 and Grade 1HD-200): Side mounted; fullextension type; zinc-plated steel ball-bearing slides.
- Box Drawer Slides: Grade 1HD-100; for drawers not more than 6 inches high and 24 inches wide.
- Exposed Hardware Finishes: For exposed hardware, provide finish that complies with BHMA A156.18 for BHMA finish number indicated.
- Satin Chromium Plated: BHMA 626 for brass or bronze base; BHMA 652 for steel base.
- For concealed hardware, provide manufacturer's standard finish that complies with product class requirements in BHMA A156.9.

#### 1.2 MISCELLANEOUS MATERIALS

- Furring, Blocking, Shims, and Hanging Strips: Softwood or hardwood lumber, kiln dried to less than 15 percent moisture content.
- Anchors: Select material, type, size, and finish required for each substrate for secure anchorage. Provide nonferrous-metal or hot-dip galvanized anchors and inserts on inside face of exterior walls and elsewhere as required for corrosion resistance. Provide toothed-steel or lead expansion sleeves for drilled-in-place
- Adhesives, General: Do not use adhesives that contain urea formaldehyde.
  - Adhesive for Bonding Plastic Laminate: Contact cement.
  - Adhesive for Bonding Edges: Hot-melt adhesive.

#### SECTION 08 11 13 HOLLOW METAL DOORS AND FRAMES

#### **MANUFACTURERS**

- Subject to compliance with requirements, available manufacturers offering products that may be incorporated into the Work include, but are not limited to, the following:
  - Amweld Building Products, LLC.
  - Ceco Door Products; an Assa Abloy Group company.
  - Curries Company; an Assa Abloy Group company.

#### DOORS AND FRAMES

- A. Construct doors and frames to comply with the standards indicated for materials, fabrication, hardware locations, hardware reinforcement, tolerances, and clearances, and as specified.
- Maximum-Duty Doors and Frames: SDI A250.8, Performance Level 4.
  - Physical Performance: Level A according to SDI A250.4.
  - Doors:
  - Type: As indicated in the Door and Frame Schedule.
  - Thickness: 1-3/4 inches
  - Face: Metallic-coated steel sheet, minimum thickness of 0.067 inch (14-gage face sheets and laminated cores), with minimum A40
  - Edge Construction: Model 2, Seamless
  - Core: Polyurethane.
  - Exterior Frames: Metallic-coated steel sheet, in thermally broken configuration.
  - Fabricate frames with mitered or coped corners.
  - Fabricate frames as full profile welded.
  - Frames for hollow metal doors minimum 0.067-inch (14-gage) thick

#### SECTION 08 80 00 - GLAZING

#### Section Includes the following:

- Glazing for the following products and applications, including those specified in other Sections where glazing requirements are specified by reference to this Section:
  - Interior Doors

#### **PRODUCTS**

#### **GLASS PRODUCTS**

- A. Float Glass: ASTM C 1036, Type I, Quality-Q3, Class I (clear) unless otherwise indicated.
- Heat-Treated Float Glass: ASTM C 1048; Type I; Quality-Q3; Class I (clear) unless otherwise indicated; of kind and condition indicated.
  - Kind FT (fully tempered) where indicated, where glazing is subject to human impact, and where required by applicable codes and regulations.

#### **GLAZING GASKETS**

- Soft Compression Gaskets: Extruded or molded, closed-cell, integral-skinned neoprene EPDM silicone or thermoplastic polyolefin rubber gaskets complying with ASTM C 509, Type II, black; of profile and hardness required to maintain watertight
  - Application: Use where soft compression gaskets will be compressed by inserting dense compression gaskets on opposite side of glazing or pressure applied by means of pressure-glazing stops on opposite side of glazing.

#### **GLAZING SEALANTS**

#### A. General:

- Compatibility: Provide glazing sealants that are compatible with one another and with other materials they will contact, including glass products, seals of insulating-glass units, and glazing channel substrates, under conditions of service and application, as demonstrated by sealant manufacturer based on testing and field experience.
- Suitability: Comply with sealant and glass manufacturers' written instructions for selecting glazing sealants suitable for applications indicated and for conditions existing at time of installation.

#### **GLAZING TAPES**

- A. Back-Bedding Mastic Glazing Tapes: Preformed, butyl-based, 100 percent solids elastomeric tape; nonstaining and nonmigrating in contact with nonporous surfaces; with or without spacer rod as recommended in writing by tape and glass manufacturers for application indicated; and complying with ASTM C 1281 and AAMA 800 for products indicated below:
  - 1. AAMA 806.3 tape, for glazing applications in which tape is subject to continuous pressure.
  - AAMA 807.3 tape, for glazing applications in which tape is not subject to continuous pressure.

#### SECTION 09 29 00 - GYPSUM BOARD

#### **INTERIOR GYPSUM BOARD**

- A. General: Complying with ASTM C 36 or ASTM C 1396, as applicable to type of gypsum board indicated and whichever is more stringent. See Editing Instruction No. 1 in the Evaluations for cautions about naming manufacturers and products. Retain one of two subparagraphs and list of manufacturers below. See Division 1 Section "Product Requirements."
  - 1. Available Manufacturers: Subject to compliance with requirements, manufacturers offering products that may be incorporated into the Work include, but are not limited to, the following:
    - American Gypsum Co.
    - National Gypsum Company. USG Corporation.
  - Core: Type X.
  - Thickness: 5/8 inch.
  - Long Edges: Tapered.

#### **SECTION 09 65 13 - RESILIENT WALL BASE AND ACCESSORIES**

#### **RESILIENT BASE (DRAWING DESIGNATION RB-1)**

- A. Manufacturers: Subject to compliance with requirements, available manufacturers offering products that may be incorporated into the Work include but are not limited to, the following:
  - Tarkett. Inc.
- Resilient Base Standard: ASTM F 1861 See "Resilient Base" Article in the Evaluations for a discussion of material requirement, manufacturing method, and style.
- Material Requirement: Type TS (rubber, vulcanized thermoset).
- Manufacturing Method: Group I (solid, homogeneous).
- Style: Cove (base with toe).
- Minimum Thickness: 0.125 inch.
- Height: 4-inches.
- Lengths: Coils in manufacturer's standard length.
- Outside Corners: Job formed.
- Inside Corners: Job formed.
- Finish: Matte.
- Colors and Patterns: As indicated on Drawings.

#### **SECTION 09 65 19 - RESILIENT TILE FLOORING**

### **LUXURY VINYL TILE (DRAWING DESIGNATION LVT-1)**

- A. Basis-of-Design Subject to compliance with requirements, available products that may be incorporated into the Work include, but are not limited to, the following:
  - Armstrong.
- Material Properties: Solid Vinyl Tile.
- Tile Properties:
- Size: 36-inches x 6-inches. Installation Method: Butt joined.
- Colors and Patterns: As indicated on Drawings by manufacturer's designations.

#### **SECTION 09 68 13 – TILE CARPETING**

#### SUMMARY

- A. Section Includes:
  - Modular, tufted carpet tile.

## **EXTRA MATERIALS**

- A. Furnish extra materials described below, before installation begins, that match products installed and that are packaged with protective covering for storage and identified with labels describing contents.
  - Carpet Tile: Full-size units equal to 5 percent of amount installed for each type indicated, but not less than 5 sq. yd.

#### **CARPET TILE: (DRAWING DESIGNATION CPT-1):**

- A. Products: Provide "Iron Ore NE811011" modular carpet tiles, by TAS
  - Size/Width: 19.7"x 19.7".
  - Installation Method: To be determined. Color: As indicated on Drawings.
  - Pattern: As indicated on Drawings.

#### **SECTION 09 91 23 INTERIOR PAINTS AND COATINGS**

#### **MANUFACTURERS**

- A. Subject to compliance with requirements, available manufacturers offering products that may be incorporated into the Work include, but are not limited to, the following:
- Sherwin-Williams Company.

#### **GYPSUM BOARD PAINT SYSTEM**

- Provide the following coating system over interior gypsum board surfaces: Primer: S-W ProMar 200 Zero VOC Latex Primer, B28W2600.
- First coat: S-W ProMar 200 Zero VOC Latex Eq-Shel, B24-2600 Series.
- Second coat: S-W ProMar 200 Zero VOC Latex Eg-Shel, B24-2600 Series.

#### **INTERIOR FERROUS METAL PAINT SYSTEM**

- A. Provide the following coating system for the ferrous surfaces:
  - Primer: S-W Pro Industrial Pro-Cryl Universal Primer, B66-310 Series. First Coat: S-W ProClassic Waterborne Acrylic Gloss Enamel, B21-2100
  - Second Coat: ProClassic Waterborne Acrylic Gloss Enamel, B21-2100

#### **SECTION 10 44 00 - FIRE PROTECTION SPECIALTIES**

#### FIRE EXTINGUISHER CABINET

- A. Cabinet Type:
- Larsen's Manufacturing Company; Model 2409-5, or similar style as required for wall thickness.
- Cabinet Construction: Nonrated.
- Cabinet Material: Steel sheet, with white baked enamel finish. Shelf: Same metal and finish as cabinet.
- Semi-recessed Cabinet: Cabinet box partially recessed in walls of sufficient depth to suit style of trim indicated; with one-piece combination trim and perimeter door frame overlapping surrounding wall surface with exposed trim face and wall return at outer edge (backbend). Provide where walls are of insufficient depth for recessed cabinets but are of sufficient depth to
  - accommodate semi-recessed cabinet installation. 1. Square-Edge Trim: 1-1/4-inch backbend depth.
- Cabinet Trim Material: Same material and finish as door.
- Door Material: Clear anodized aluminum. Door Style: Fully glazed panel with frame.
- H. Door Glazing: Clear acrylic sheet.
- Door Hardware: Manufacturer's standard door-operating hardware of proper type for cabinet type, trim style, and door material and style indicated.

### Accessories:

- Mounting Bracket: Manufacturer's standard steel, designed to secure fire extinguisher to fire extinguisher cabinet, of sizes required for types and capacities of fire extinguishers indicated, with plated or baked-enamel
- Identification: Identify fire extinguisher in fire extinguisher cabinet with the words "FIRE EXTINGUISHER."

  - Location: Applied to door glazing. Application Process: Decals or pressure-sensitive vinyl letters.
- Lettering Color: Red. Orientation: Vertical.

PORTABLE, HAND-CARRIED FIRE EXTINGUISHERS

A. Fire Extinguishers: Provide new fire extinguishers for each fire extinguisher cabinet and mounting bracket indicated.

1. Provide Larsen model MP5, UL rating 2A-10B:C.


**SECTION 11 31 00 - RESIDENTIAL APPLIANCES** 

## **KITCHEN**

- A. Refrigerator: Model GTS22KYNRFS by GE or equal. Type: Top-Freezer
  - Dimensions:
  - Width: 32 3/4 inches. Depth: 34 1/2 inches.
  - c. Height: 66 3/8 inches. Appliance Finish Color: Stainless Steel.

#### **GENERAL NOTES:**

SPECIFICATIONS ABOVE ARE NOT ALL INCLUSIVE OF PRODUCTS AND MATERIALS REQUIRED FOR THE THIS PROJECT. SEE DRAWINGS AND FINISH SCHEDULE FOR ADDITIONAL PRODUCT REFERENCES AND DETAILS.

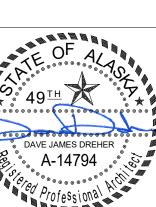

Professional Month

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DENALI 009

DATE: 6/15/22

DRAWN: HLC

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lacksquare

CHECKED: DJD PROJECT: 1718.74

DRAWING TITLE:

**SPECIFICATIONS** 

**REVISIONS:** 

SHEET NO:

DEMOLITION FLOOR PLAN

Scale: 1/4" = 1'-0"



E C T S LLC nchorage Alaska 99501

A R C H I T E C T S 880 N Street Suite 302 | Anchorage Al T: 907.929.9334 | www.burkhart-c

SAC LIBRARY TRAINI ROOM

DATE: 6/15/22

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PROJECT: 1718.74

DRAWING TITLE:

DEMOLITION FLOOR PLAN

REVISIONS:

SHEET NO:

HATCH INDICATES NO WORK IN THIS AREA

FF=====F7
!! REMOVE ACOUSTIC CEILING TILES AND GRID

## **DEMOLITION SHEET NOTES**

- D1 REMOVE CASEWORK
- D2 REMOVE (E) SINK SALVAGE FOR NEW WORK
- D4 REMOVE (E) FLOORING AND BASE
- D5 (E) COUTERTOP TO REMAIN
- D6 REMOVE AND TERMINATE (E) ELECTRICAL RACEWAY
- D7 REMOVE (E) LIGHT FIXTURE FOR RELOCATION
- D8 (E) FUME HOOD TO REMAIN
- D9 USE THIS (E) RECEPTACLE / CIRCUIT FOR NEW GFCI AT OPPOSITE CASEWORK
- D10 REMOVE (E) DOOR SALVAGE FOR NEW WORK
- D11 REMOVE (E) CEILING AS INDICATED
- D12 REMOVE PORTION OF (E) WALL ASSEMBLY UP TO HEIGHT OF (N) CEILING



DEMOLITION REFLECTED CEILING PLAN

LIBR/ ROC 3600 DENALI STREET AI

DATE: 6/15/22


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PROJECT: 1718.74

DRAWING TITLE: DEMOLITION RELECTED CEILING PLAN

REVISIONS:

SHEET NO:

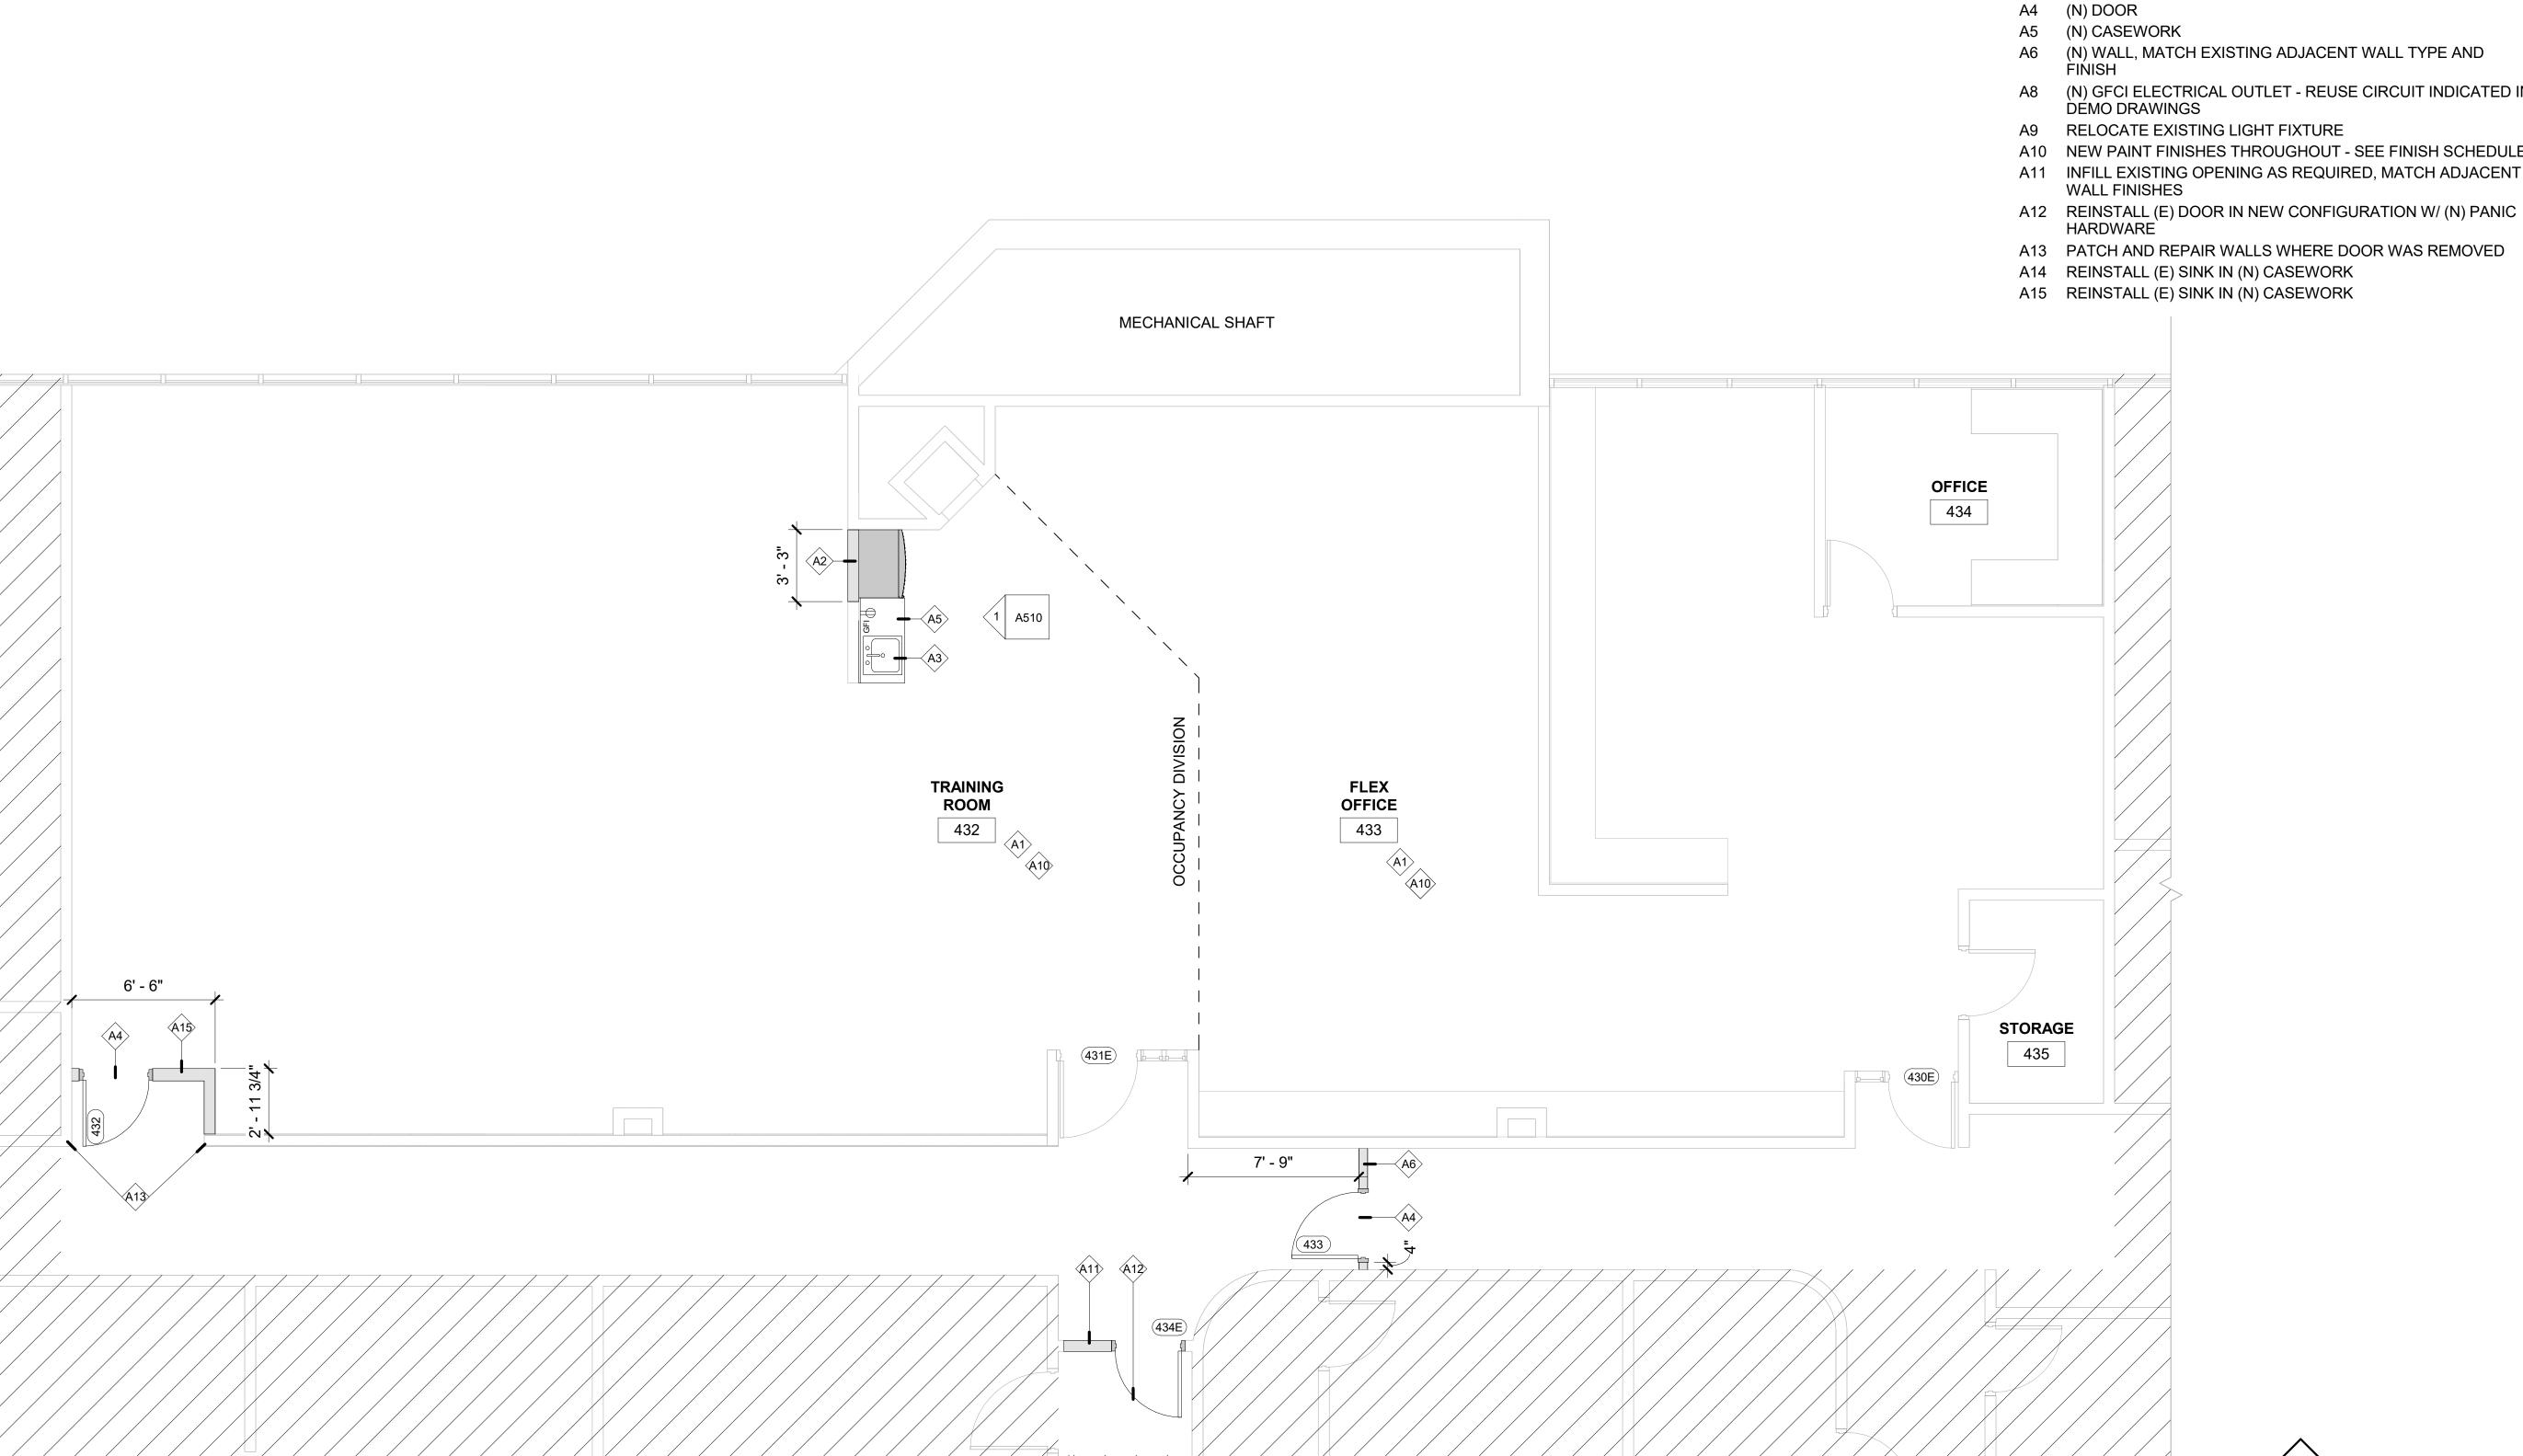

FLOOR PLAN
Scale: 1/4" = 1'-0"



A1 (N) FLOORING AND WALL BASE

A2 (N) WALL PARTITION ON TOP OF HALF WALL, MATCH ADJACENT WALL FINISH

A3 (N) SINK

(N) WALL, MATCH EXISTING ADJACENT WALL TYPE AND

(N) GFCI ELECTRICAL OUTLET - REUSE CIRCUIT INDICATED IN DEMO DRAWINGS

A9 RELOCATE EXISTING LIGHT FIXTURE

A10 NEW PAINT FINISHES THROUGHOUT - SEE FINISH SCHEDULE A11 INFILL EXISTING OPENING AS REQUIRED, MATCH ADJACENT

A13 PATCH AND REPAIR WALLS WHERE DOOR WAS REMOVED

A14 REINSTALL (E) SINK IN (N) CASEWORK

A15 REINSTALL (E) SINK IN (N) CASEWORK



LIBR/ ROC 3600 DENALI STREET AI **LOUSS**/

DATE: 6/15/22

DRAWN: HLC

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PROJECT: 1718.74

DRAWING TITLE: FLOOR PLAN

REVISIONS:

SHEET NO:



A1 (N) FLOORING AND WALL BASE

A2 (N) WALL PARTITION ON TOP OF HALF WALL, MATCH ADJACENT WALL FINISH

A3 (N) SINK

(N) WALL, MATCH EXISTING ADJACENT WALL TYPE AND

A8 (N) GFCI ELECTRICAL OUTLET - REUSE CIRCUIT INDICATED IN DEMO DRAWINGS

A9 RELOCATE EXISTING LIGHT FIXTURE

A10 NEW PAINT FINISHES THROUGHOUT - SEE FINISH SCHEDULE

A11 INFILL EXISTING OPENING AS REQUIRED, MATCH ADJACENT WALL FINISHES

A12 REINSTALL (E) DOOR IN NEW CONFIGURATION W/ (N) PANIC

A13 PATCH AND REPAIR WALLS WHERE DOOR WAS REMOVED

A14 REINSTALL (E) SINK IN (N) CASEWORK

A15 REINSTALL (E) SINK IN (N) CASEWORK

LIBR/ ROC **LOUSS**/

3600 DENALI STREET A

DATE: 6/15/22

DRAWN: HLC CHECKED: DJD

PROJECT: 1718.74

DRAWING TITLE: REFLECTED CEILING PLAN

REVISIONS:

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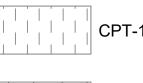
**A202** 

REFELCETED CEILING PLAN


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## FINISH FLOOR PLAN LEGEND







1 FINISH FLOOR PLAN

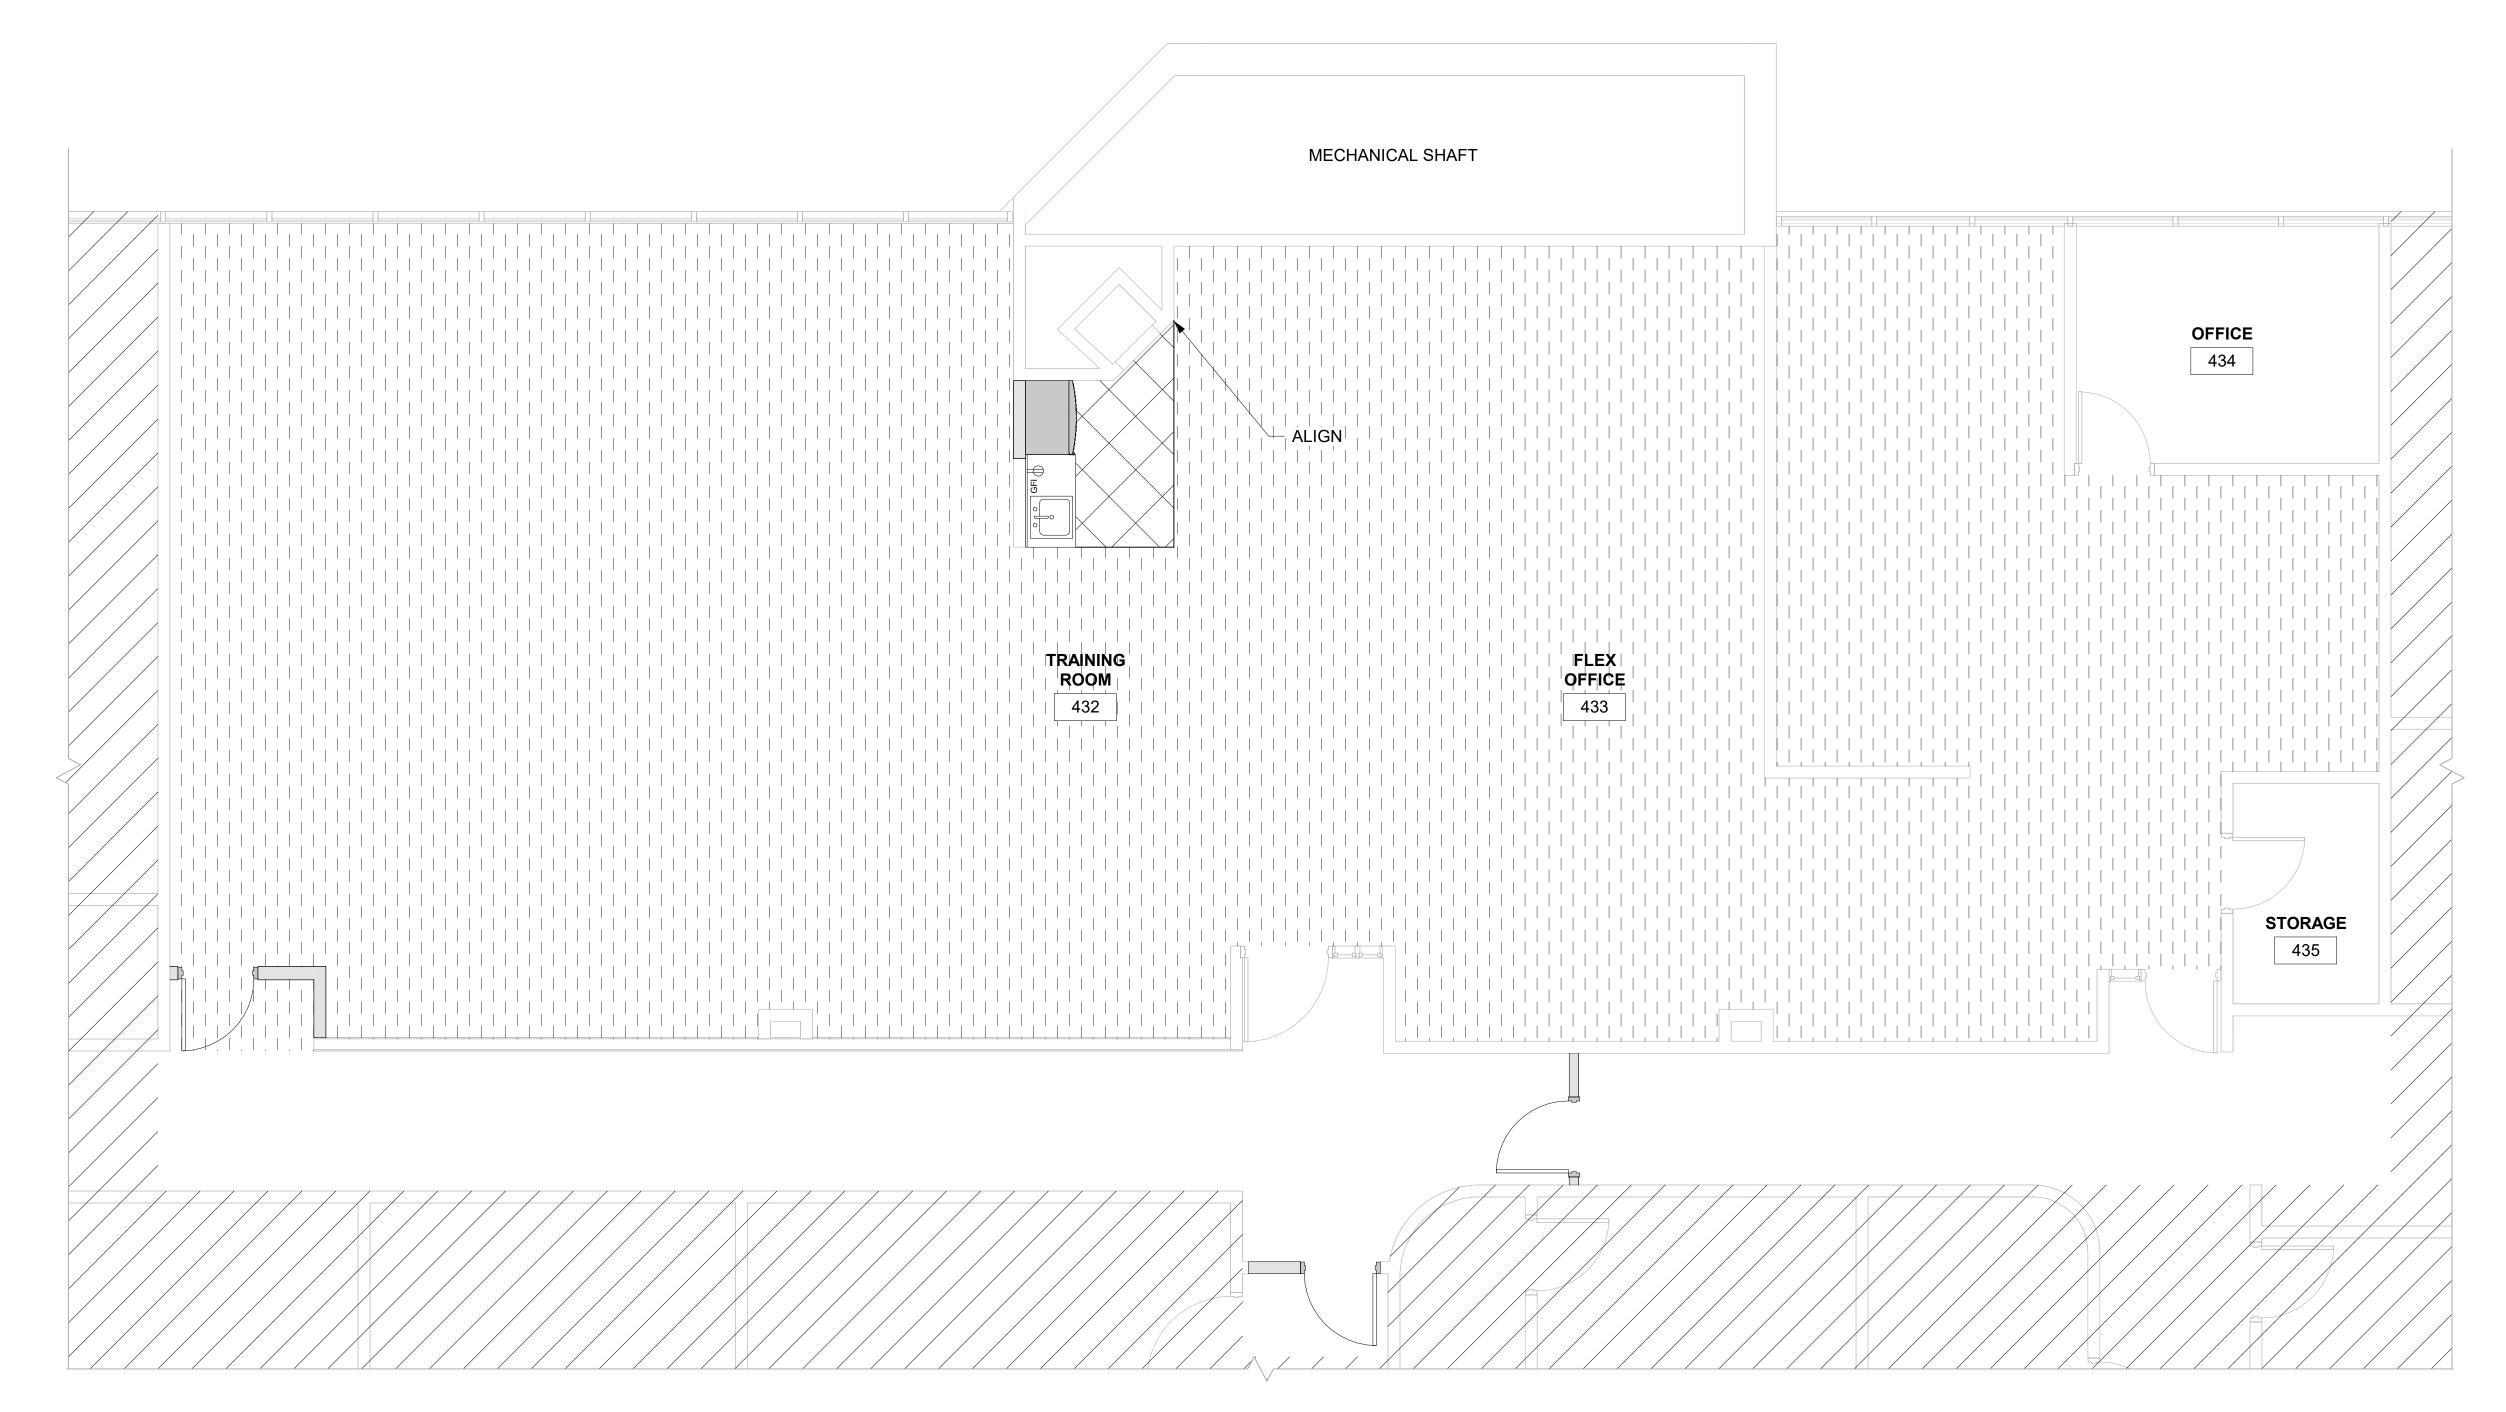DATE: 6/15/22

DRAWN: HLC

LIBRARY ROOM

3600 DENALI STREET AI

CHECKED: DJD

PROJECT: 1718.74

DRAWING TITLE:
FINISH FLOOR PLAN


REVISIONS:

SHEET NO:

[1/A202] Scale: 1" = 1'-0"

## ARCHITECTURAL SHEET NOTES

- A1 (N) FLOORING AND WALL BASE
- A2 (N) WALL PARTITION ON TOP OF HALF WALL, MATCH ADJACENT WALL FINISH
- A3 (N) SINK
- A4 (N) DOOR
- (N) CASEWORK
- (N) WALL, MATCH EXISTING ADJACENT WALL TYPE AND
- A8 (N) GFCI ELECTRICAL OUTLET REUSE CIRCUIT INDICATED IN DEMO DRAWINGS
- A9 RELOCATE EXISTING LIGHT FIXTURE
- A10 NEW PAINT FINISHES THROUGHOUT SEE FINISH SCHEDULE
- A11 INFILL EXISTING OPENING AS REQUIRED, MATCH ADJACENT WALL FINISHES
- A12 REINSTALL (E) DOOR IN NEW CONFIGURATION W/ (N) PANIC
- A13 PATCH AND REPAIR WALLS WHERE DOOR WAS REMOVED
- A14 REINSTALL (E) SINK IN (N) CASEWORK
- A15 REINSTALL (E) SINK IN (N) CASEWORK

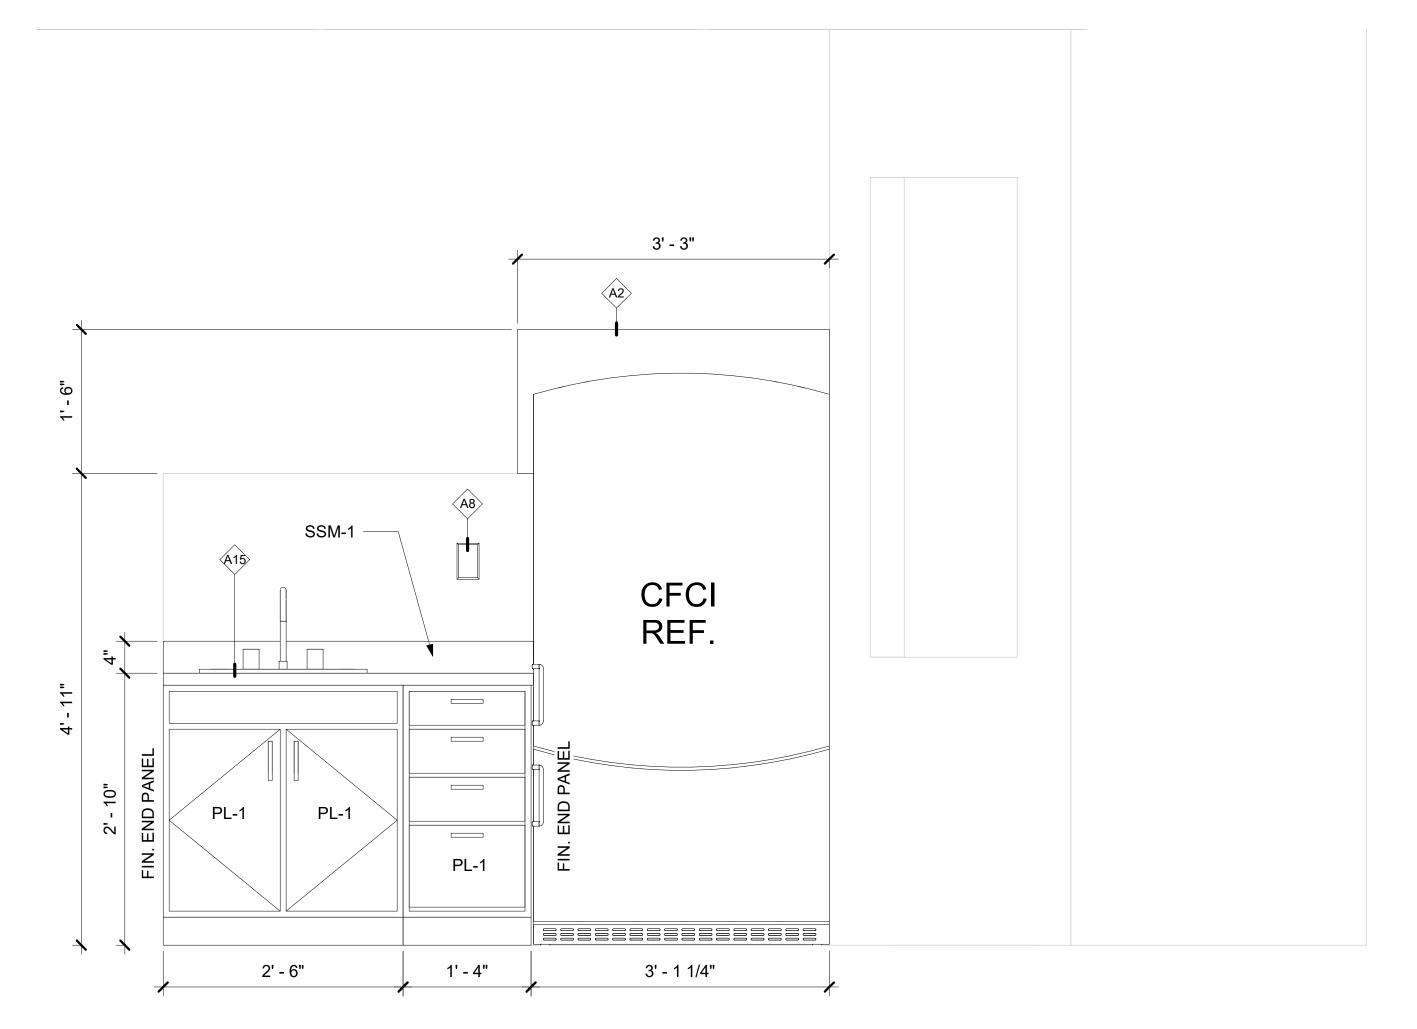

KITCHENETTE ELEVTION

[1/A201] Scale: 1" = 1'-0"

LIBR/ ROC 3600 DENALI STREET AI

DATE: 6/15/22

DRAWN: HLC

CHECKED: DJD

PROJECT: 1718.74 DRAWING TITLE:

INTERIOR ELEVATIONS / WALL SECTIONS


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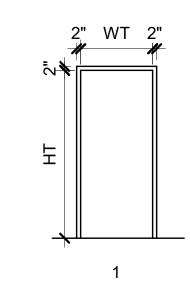
SHEET NO:

ROOM FINISH SCHEDULE											
						WALLS					
ROOM NAME	ROOM NUMBER	FLOOR FINISH	BASE	WALL MATERIAL	WALL FINISH NORTH	WALL FINISH EAST	WALL FINISH SOUTH	WALL FINISH WEST	CEILING MATERIAL	CEILING FINISH	MISC REMARKS
TRAINING ROOM	432	CPT-1/LVT-1	RB-1	GWB	PNT-1	PNT-1	PNT-1	PNT-1	(E)ACP		
OFFICE	434	-	-	-	-	-	-	-	-		
STORAGE	435	-	-	-	-	-	-	-	-		
FLEX OFFICE	433	CPT-1	RB-1	GWB	PNT-1	PNT-1	PNT-1	PNT-1	(E)ACP		

FINISH MATERIAL LEGEND							
CODE	TYPE	MANUFACTURER	COLLECTION/TYPE	COLOR	SIZE/THICKNESS	REMARKS	
ACCESSORIES							
WB-1	WALL BASE	JOHNSONITE	TRADITIONAL BASE	BURNT UMBER			
CASEWORK							
PL-1	PLASTIC LAMINATE	FORMICA	WOODGRAINS	NATURAL MAPLE (756-58)			
SSM-1	SOLID SURFACE MATERIAL	CORIAN		SILVER LINEAR			
FLOORING							
CPT-1	CARPET TILE	TAS FLOORING	DEVELOPMENT	CARBON (NE811022)	19.7 x 19.7		
LVT-1	LUXURY VINYL TILE	ARMSTRONG FLOORING	EXCHANGE	ST910 STATIC, CATHODE GREY	6 x 36		
PAINT							
PNT-1	PAINT	SHERWIN WILLIAMS		SW 0050 CLASSIC LIGHT BUFF			

	DOOR SCHEDULE											
			DC	OR				,	FRAME			
		SIZE	,							FIRE		
DOOR NO	WIDTH	HEIGHT	THICKNESS	TYPE	MATERIAL	FINISH	TYPE	MATERIAL	FINISH	RATING	HARDWARE	REMARKS
430E	3' - 0"	7' - 0"	1 3/4"	В	НМ	PAINT-MATCH EXISTING	1	НМ	PAINT-MATCH EXISTING		(E)	
431E	3' - 6"	7' - 0"	1 3/4"	В	НМ	PAINT-MATCH EXISTING	1	НМ	PAINT-MATCH EXISTING		2	
432	3' - 0"	7' - 0"	1 3/4"	Α	IHM	PAINT-MATCH EXISTING	1	НМ	PAINT-MATCH EXISTING		1	
433	3' - 0"	7' - 0"	1 3/4"	В	НМ	PAINT-MATCH EXISTING	1	НМ	PAINT-MATCH EXISTING		1	
434E	3' - 0"	7' - 0"	1 3/4"	В	НМ	PAINT-MATCH EXISTING	1	HM	PAINT-MATCH EXISTING		2	



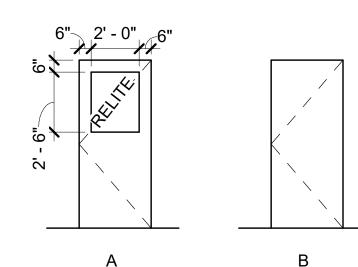

LEGEND- DOOR TYPES

Scale: 1/4" = 1'-0"

LEGEND- FRAME TYPES

Scale: 1/4" = 1'-0"

#### **HARDWARE GROUPS**

Code Description
AL Aluminum
130 RiteCoat Painted - Satin Aluminum
626 Satin Chromium Plated
628 Satin Aluminum, Clear Anodized

630 Satin Stainless Steel 689 Aluminum Painted

GREYGrey

US26D Chromium Plated, Dull US32D Stainless Steel, Dull

#### **Manufacturer List**

Code Name
AB ABH Manufacturing Inc.

AB ABH Manufacturing Inc.
AD Adams Rite
BE Best Access Systems
BEST BEST
DM Dorma Door Controls
NA National Guard
PR Precision
ST Stanley

TR Trimco

## SET #01

3	Hinges	FBB168 4 1/2 X 4 1/2	US26D	ST
1	Exit Device	2414 X 2914D	630	PR
1	Closer	8916 SPA	689	DM
1	Wall Bumper	1270CV	626	TR

## SET #02

LI #UZ			
Exit Device	2414 X 2914D	630	PR
Wall Bumper	1270CV	626	TR



**TRAINING** ARY

LIBRA ROC STREET AN 3600 DENALI

DATE: 6/15/22

DRAWN: HLC


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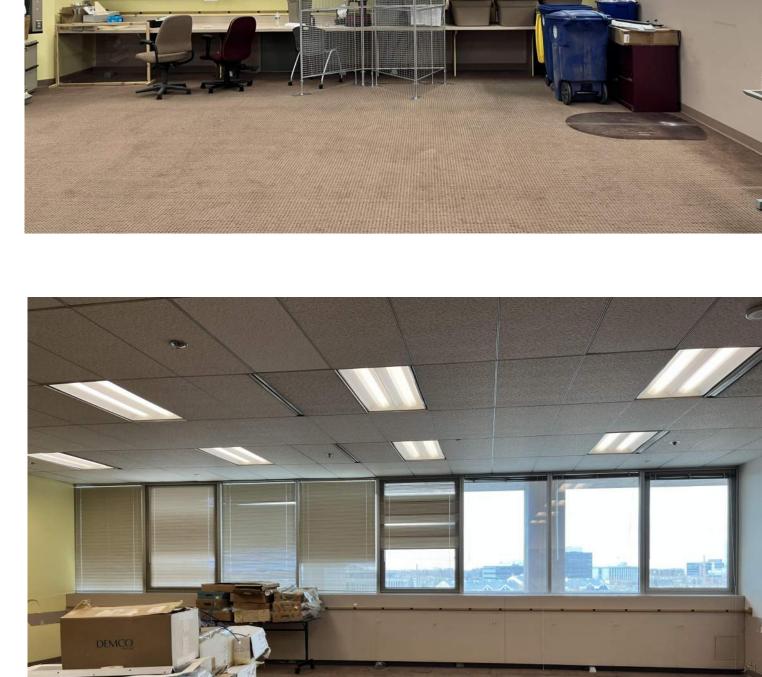
PROJECT: 1718.74

DRAWING TITLE: ROOM FINISH SCHEDULE, FINISH MATERIAL LEGEND, DOOR SCHEDULE

REVISIONS:

SHEET NO:




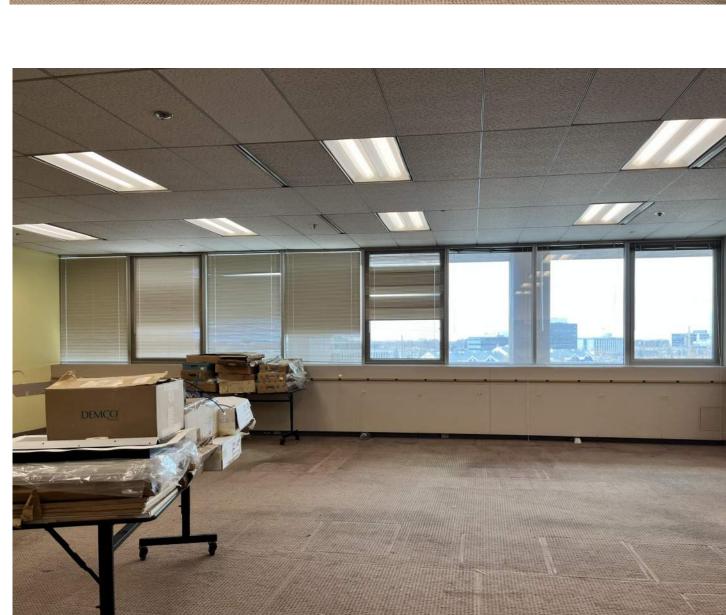








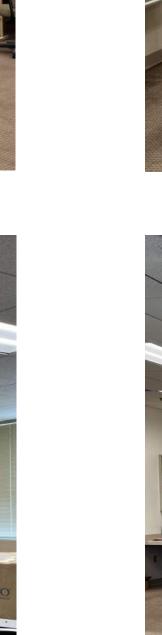

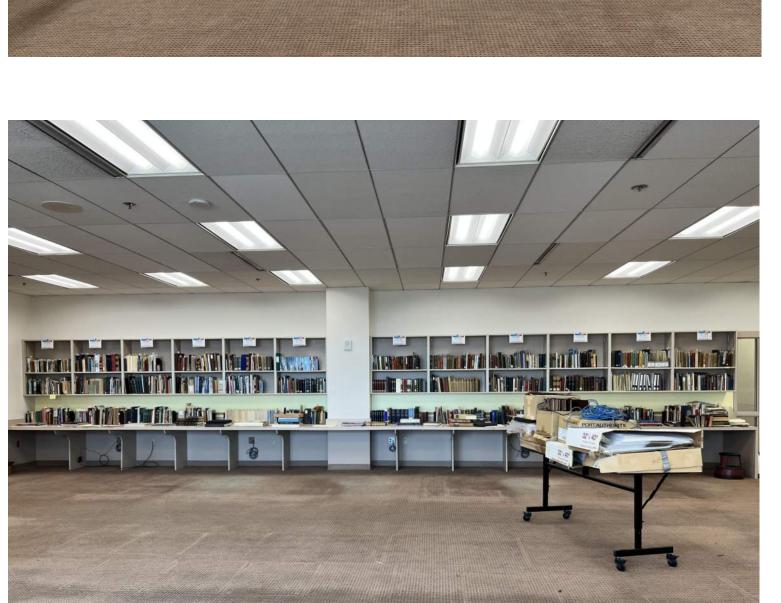







3600 DENALI STREET A

DATE: 6/15/22 DRAWN: HLC CHECKED: DJD

PROJECT: 1718.74

REVISIONS:

PHOTOS

DRAWING TITLE:

SHEET NO: