
# MUNICIPALITY OF ANCHORAGE OSCAR ANDERSON HOUSE MUSEUM ROOF REPLACEMENT & REPAINTING

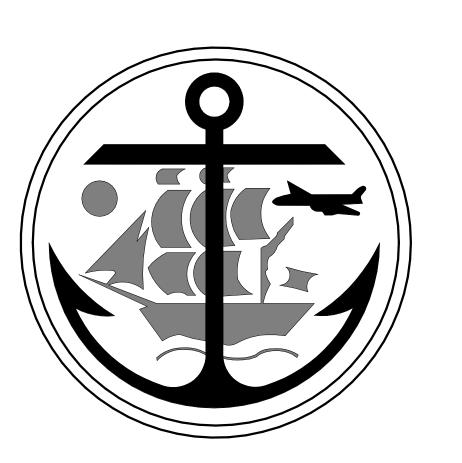

## ANCHORAGE, ALASKA

**OWNER** 

## **MUNICIPALITY OF ANCHORAGE** MAINTENANCE & OPERATIONS

3640 E TUDOR ROAD, WAREHOUSE NO. 1 ANCHORAGE, ALASKA 99507

## **ARCHITECT**

## **BURKHART CROFT ARCHITECTS, LLC**

880 N STREET, SUITE 302 ANCHORAGE, ALASKA 99503

## ALTERNATE SCHEDULE

**ALTERNATE NO. 1:** ALL VERTICAL WORK. TO INCLUDE NEW PAINTING AND SIDING REPLACEMENT. AND AS INDICATED IN THE DRAWINGS

## INDEX TO DRAWINGS

## **GENERAL**

## **ARCHITECTURAL**

**PHOTOS** 

**ROOF PLANS - DEMO & NEW** 

## **DESCRIPTION OF WORK**

PROJECT INCLUDES REMOVAL AND REPLACEMENT OF AN EXISTING, CEDAR IN USE OF THE FACILITY ARE PROPOSED IN THIS WORK

NOTE: THIS FACILITY IS ON THE NATIONAL HISTORIC REGISTRY, ANY MODIFICATION BEYOND WHAT IS INDICATED IN THESE DOCUMENTS REQUIRES PRIOR APPROVAL

## **GENERAL NOTES**

PLYWD plywood


- DIMENSIONS ARE TO FACE OF EXTERIOR FINISH UNLESS NOTED
- CONTRACTOR TO FIELD VERIFY ALL SITE CONDITIONS, DIMENSIONS, AND ELEVATIONS PRIOR TO THE START OF WORK

## **ABBREVIATIONS**

exterior existing

@	at	FT	feet	PLYWD	piywood paint
#	pound or number	GA	gauge or gage	PT	pressure treated
ABBRS ADD ADJ AFF APPROX ARCH	abbreviations additive adjustable above finished floor approximate architectural	GWB HORIZ HT HVAC	gypsum wall board horizontal height heating, ventilating, and air conditioning	(R) RAD RD REQ RO	relocated radius roof drain required rough opening
BD BLK BO	board block or blocking bottom of	INSUL MAX MECH	insulation maximum mechanical	SECT SIM SPEC	section similar specification
CMU CONT	concrete masonry unit continuous	MFR MIN	manufacturer minimum, minute	SQ STRUCT	square structural
DEMO DET	demolition detail	MISC MTL	miscellaneous metal	T.O. TYP	top of typical
DIA DIM DN DS	diameter dimension down downspout	(N) NIC NOM NTS	new not in contract nominal not to scale	U.N.O. VAR VB	unless noted otherwise varies vapor barrier
DWG (E) EA	drawing existing each	OD OFCI OFOI	overflow drain owner furnished, contractor installed owner furnished, owner installed	VERT VIF VTR	vertical verification in field vent through roof
EL ELEC EQ EQUIP	elevation electrical equal equipment	OPH OSB OS	opposite hand oriented strand board overflow scupper	W/ WB WD	with weather barrier wood

## **SYMBOLS**

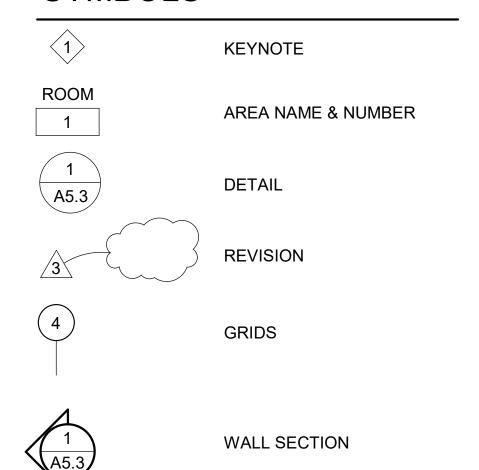

## **CODE ANALYSIS**

APPLICABLE BUILDING CODES 2018 INTERNATIONAL BUILDING CODE

ADDRESS: 420 M ST, ANCHORAGE, ALASKA 99501 **BLOCK**: LANDMARK LT 1

R3 (MIXED RESIDENTIAL / COMMERCIAL)

2 STORIES ABOVE GRADE WITH OCCUPIED BASEMENT

V-B (WITH AUTOMATIC SPRINKLER SYSTEM PROTECTION)

**OCCUPANCY**: **GROUP A3 - MUSEUM** 

TABLE 504.3: GROUP A, TYPE V-B = 9,000 SF x 2 (SPRINKLER INCREASE - 506.3) =18,000sf.

**TABLE 601:** FIRE RESISTANCE RATING: 0-HOUR FIRE RESISTANCE PROVIDED **TABLE 602:** FIRE RESISTANCE FOR EXTERIOR WALLS 30' MINIMUM SEPARATION DISTANCE TO PROPERTY LINES, 1-HR LESS THAN 5 < OK NO FIRE

RESISTANCE REQUIRED ACTUAL GREATER THEN 20 FEET>

MINIMUM CLASS C ROOF ASSEMBLY REQUIRED IN TYPE VB CONSTRUCTION.


TABLE 1505.1:

FLOOR AREA BASEMENT: 717 SF LEVEL 1 LEVEL 2 220 SF

BUILDING HEIGHT: 30'-0"

## **VICINITY MAP**



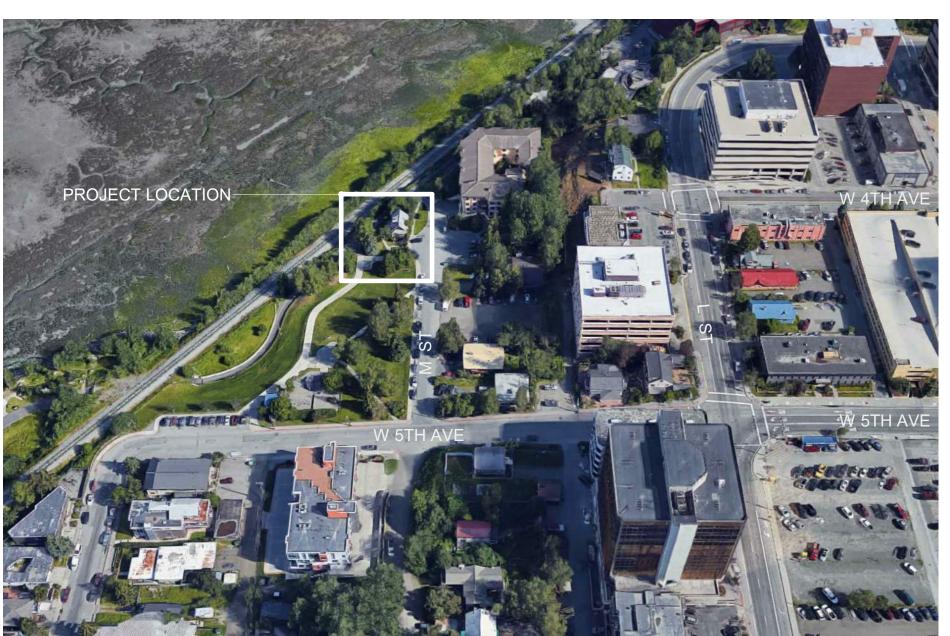

DATE: 5/24/22 DRAWN: JB CHECKED: DJD PROJECT: 1718.65 DRAWING TITLE: COVER **REVISIONS:** 

SHEET NO:

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## **SPECIFICATIONS**

#### **SECTION 02 41 19 - SELECTIVE DEMOLITION**

#### **EXAMINATION**

- A. Verify that utilities have been disconnected and capped before starting selective demolition operations.
- B. When unanticipated mechanical, electrical, or structural elements that conflict with intended function, design or routing of new material are encountered, investigate and measure the nature and extent of conflict. Promptly submit a written report to Architect.

#### **CUTTING AND PATCHING**

- A. Cutting and Patching, General: Employ skilled workers to perform cutting and patching. Proceed with cutting and patching at the earliest feasible time, and complete without delay. Do not cut and patch structural or operating elements and related components in a manner that results in reducing their capacity to perform as intended or that results in increased maintenance or decreased operational life or safety.
- B. Protection: Protect in-place construction during cutting and patching to prevent damage. Provide protection from adverse weather conditions for portions of Project that might be exposed during cutting and patching operations.
- C. Cutting: Cut in-place construction by sawing, drilling, breaking, chipping, grinding, and similar operations, including excavation, using methods least likely to damage elements retained or adjoining construction.
- Patching: Patch construction by filling, repairing, refinishing, closing up, and similar operations following performance of other work. Patch with durable seams that are as invisible as practicable. Provide materials and comply with installation requirements specified in other Sections, where applicable.
- E. Cleaning: Clean areas and spaces where cutting and patching are performed. Remove paint, mortar, oils, putty, and similar materials from adjacent finished surfaces.

#### **SELECTIVE DEMOLITION, GENERAL**

- A. General: Demolish and remove existing construction only to the extent required by new construction and as indicated. Use methods required to complete the Work within limitations of governing regulations and as follows:
  - 1. Neatly cut openings and holes plumb, square, and true to dimensions required. Use cutting methods least likely to damage construction to remain or adjoining construction. Use hand tools or small power tools designed for sawing or grinding, not hammering and chopping, to minimize disturbance of adjacent surfaces. Temporarily cover openings to remain.
  - 2. Locate selective demolition equipment and remove debris and materials so as not to impose excessive loads on supporting walls, floors, or framing.
- 3. Dispose of demolished items and materials promptly.
- B. Removed and Reinstalled Items:
  - 1. Clean and repair items or materials to functional condition adequate for intended reuse.
  - 2. Store items or materials after cleaning and repairing. Protect with appropriate cover and label according to location of removal.
  - Protect items from damage during storage, handling and re-installation.
     Reinstall items in locations indicated. Comply with installation requirements for new materials and equipment. Provide
  - connections, supports, and miscellaneous materials necessary to make item functional for use indicated. Replace all damaged components with materials to match existing.
- C. Existing Items to Remain: Protect construction indicated to remain against damage and soiling during selective demolition and subsequent construction activities. When permitted by Architect, items may be removed to a suitable, protected storage location during selective demolition and reinstalled in their original locations after selective demolition operations are complete.

## SECTION 06 10 53 MISCELLANEOUS ROUGH CARPENTRY

## WOOD PRODUCTS, GENERAL

- A. Lumber: DOC PS 20 and applicable rules of grading agencies indicated. Provide lumber graded by an agency certified by the ALSC Board of Review to inspect and grade lumber under the rules indicated.
  - 1. Factory mark each piece of lumber with grade stamp of grading agency.
  - 2. Where nominal sizes are indicated, provide actual sizes required by DOC PS 20 for moisture content specified. Where actual sizes are indicated, they are minimum dressed sizes for dry lumber.
  - 3. Provide dressed lumber, S4S, unless otherwise indicated.

### **MISCELLANEOUS LUMBER**

- A. General: Provide miscellaneous lumber indicated and lumber for support or attachment of other construction.
- B. For concealed boards, provide lumber of the following species and grade:
  - 1. Hem-Fir, Construction or No. 2 Common grade; NLGA, WCLIB, or WWPA.

### **FASTENERS**

- A. General: Provide fasteners of size and type for material and by manufacture where required.
- 1. Where carpentry is exposed to weather, or in roof assemblies, provide fasteners of Type 304 stainless steel.
- B. Power-Driven Fasteners: NES NER-272. Wood Screws: ASME B18.6.1

## SECTION 07 30 10 - ROOFING UNDERLAYMENT

### PRODUCTS

- A. Basis of Design manufacturer: GCP Applied Technologies
  - 1. Basis of Design Product: Grace Ice & Water Shield

### SECTION 07 42 13 - STANDING SEAM METAL ROOF SYSTEM

## PRODUCTS

- A. Basis of Design manufacturer: AEP SPAN
- B. Basis of Design Product: Select Seam Narrow Batten metal roof panels.
  - 1. Color: Vintage
- C. Flashings and Trim
  - 1. Provide prefinished and color matched trims, outside corners,drips, ridge, and hip flashing per manufacturer standards.



Vrkhart Cross
ARCHITECTS LLC

N Street Suite 302 | Anchorage Alaska 99

SCAR ANDERSON HOUSE MUSEUM
ROOF REPLACEMENT & EXTERIOR
REFURBISHMENT
420 M ST, ANCHORAGE, ALASKA

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DATE: 5/24/22

CHECKED: DJD

PROJECT: 1718.65

DRAWING TITLE:

**SPECIFICATIONS** 

**REVISIONS:** 

DRAWN: JB

## GENERAL NOTES:

 SPECIFICATIONS ABOVE ARE NOT ALL INCLUSIVE OF PRODUCTS AND MATERIALS REQUIRED FOR THE THIS PROJECT. SEE DRAWINGS AND FINISH SCHEDULE FOR ADDITIONAL PRODUCT REFERENCES AND DETAILS.

SHEET NO:

G102

METERS IN PLACE. PAINT PREPARE SURFACE OF CONDUIT FOR NEW PAINT TO MATCH EXISTING

ADD ALT #1: PREPARE EXISTING SIDING PANELS AND TRIM TO RECEIVE NEW PAINT TO MATCH EXISTING, TYPICAL

**ADD ALT #1: PREPARE EXISTING** WINDOW TRIM AND SASH SURFACES FOR NEW PAINT TO MATCH EXISTING, TYPICAL

MECHANICAL AND PLUMBING VENTS IN PLACE. REPLACE FLASHING IN COORDINATION WITH NEW METAL ROOF ASSEMBLY, **TYPICAL** 

REMOVE ALL EXISTING CEDAR SHAKE ROOF FINISH AND UNDERLAYMENT. EXISTING ROOF SHEATHING TO REMAIN. INSPECT AND REPLACE DAMAGED SHEATHING AS **NECESSARY** 

ADD ALT #1: PROTECT IN PLACE EXISTING SCREEN DOOR. PREPARE SURFACE FOR NEW PAINT TO MATCH **EXISTING** 

ADD ALT #1: PREPARE EXISTING DOOR TRIM SURFACES FOR NEW PAINT TO MATCH EXISTING FLASHING AND REFER TO DETAILS FOR NEW FINISHES AND ASSEMBLY, **TYPICAL** 

ADD ALT #1: PROTECT EXISTING WINDOW SILL IN PLACE, PREPARE SURFACE FOR NEW PAINT TO MATCH EXISTING. REFER TO DETAILS FOR **NEW ROOF FINISH** INTERFACE AND FLASHING



PROTECT IN PLACE EXISTING LIGHT FIXTURE, **TYPICAL** 

ADD ALT #1: PREPARE — EXISTING PORCH CEILING FINISH TO RECEIVE NEW PAINT TO MATCH EXISTING REMOVE AND REPLACE
EXISTING KNEE BRACE
BEARING ON CEDAR
SHAKE FINISHES TO REMOVED, TYPICAL EACH SIDE OF FACADE

## EXTERIOR KNEE BRACE DETAIL @ SOUTHEAST ENTRY



EXTERIOR EAST FACADE

ADD ALT #1 NOTE: MAINTAIN EXISTING TRIM TO THE

WOOD SPECIES AS THE EXISTING

GREATEST EXTENT POSSIBLE. REPAIRS USING FILLING AND SMOOTHING COMPOUNDS IS ACCEPTABLE. IF WOOD REPLACEMENT IS REQUIRED, REPLACE WITH THE SAME

ADD ALT #1: PREPARE EXISTING SOFFIT FOR NEW PAINT TO MATCH EXISTING, TYPICAL

ADD ALT #1: PREPARE EXISTING BEAM AND TRIM, FOR NEW PAINT TO MATCH EXISTING

ADD ALT #1: PREPARE EXISTING PANEL SIDING, TRIM AND SILL FOR NEW PAINT TO MATCH EXISTING. REPAIR DAMAGED PANELS AND TRIM AS **NECESSARY** 

ADD ALT #1: PREPARE EXISTING WINDOW TRIM AND SASH SURFACES FOR NEW PAINT TO MATCH EXISTING. REPAIR DAMAGED SILL AND TRIM AS

PROTECT EXISTING VENT TO REMAIN IN PLACE


ADD ALT #1: CAREFULLY REMOVE EXISTING **GABLE WALL** WINDOW TRIM STORE, AND PREPARE SURFACES FOR REINSTALLATION AND (N) PAINT TO MATCH EXISTING REMOVE ALL EXISTING CEDAR SHAKE ROOF FINISH AND UNDERLAYMENT. EXISTING ROOF SHEATHING TO REMAIN. INSPECT AND REPLACE DAMAGED

ADD ALT #1: PREPARE EXISTING WINDOW TRIM AND SASH SURFACES FOR NEW PAINT TO MATCH EXISTING, TYPICAL

SHEATHING AS

NECESSARY

ADD ALT #1: PREPARE EXISTING VENT HOOD SURFACES FOR NEW PAINT TO MATCH EXISTING, TYPICAL

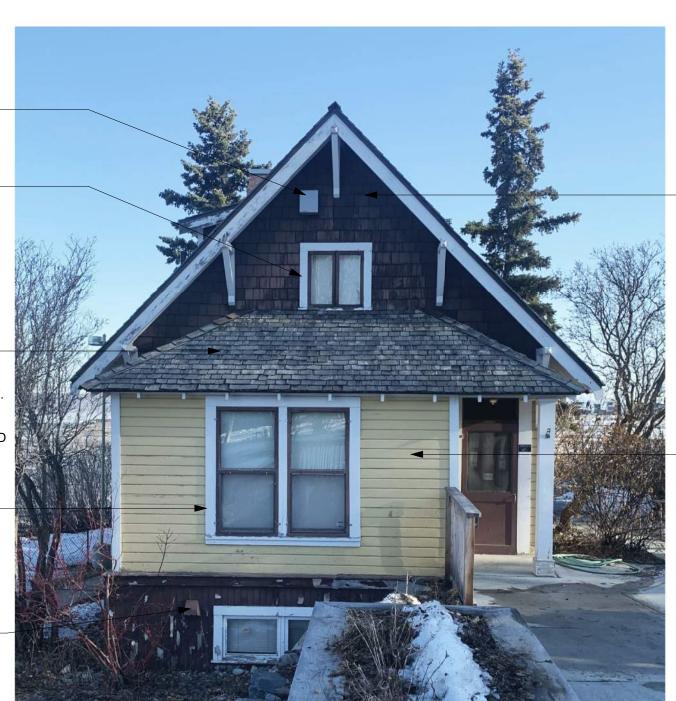

REMOVE EXISTING CEDAR SHAKE SIDING AND UNDERLAYMENT **EXISTING WALL** SHEATHING TO REMAIN. REPAIR DAMAGED SHEATHING AS NECESSARY. REFER TO DETAILS FOR NEW SIDING, UNDERLAYMENT AND FLASHING


PREPARE EXISTING SIDING PANEL SURFACES FOR NEW PAINT TO MATCH EXISTING, TYPICAL

ADD ALT #1: REMOVE EXISTING ENTRYWAY SIGNAGE AND BRACKETS. STORE AND REINSTALL TO PRIOR LOCATION UPON COMPLETION OF REFURBISHMENT

PAINT TO MATCH

EXISTING, TYPICAL

ADD ALT #1: PREPARE EXISTING COLUMN, CAP, AND BASE SURFACES FOR NEW PAINT TO MATCH EXISTING

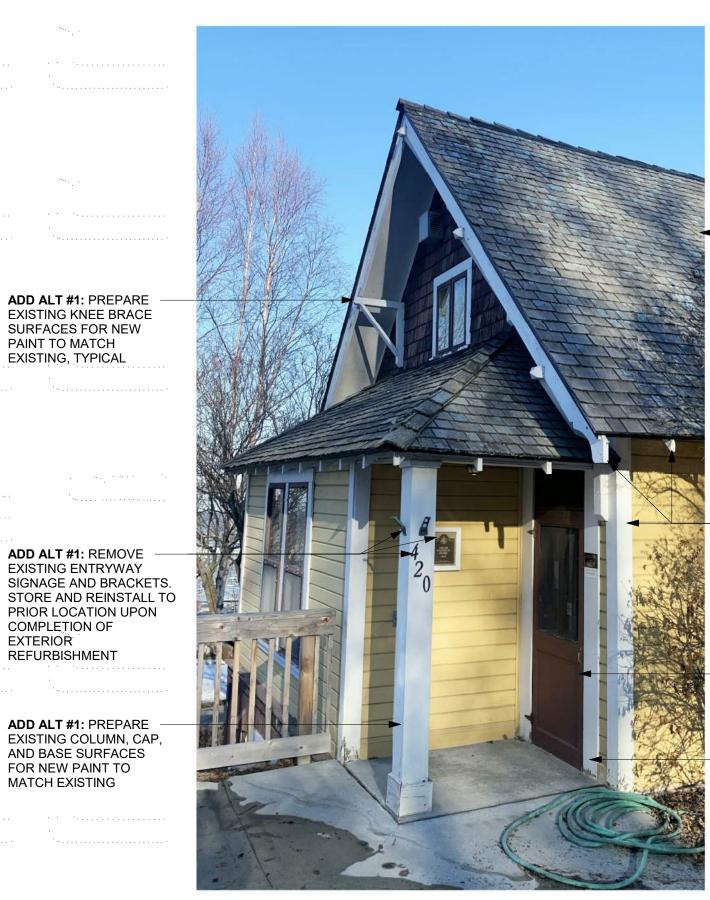

REMOVE ALL EXISTING CEDAR SHAKE ROOF FINISH AND UNDERLAYMENT. **EXISTING ROOF** SHEATHING TO REMAIN INSPECT AND REPLACE DAMAGED SHEATHING AS NECESSARY

ADD ALT #1: PROTECT IN PLACE EXISTING RAFTER TAILS, FASCIA, AND CORNER TRIM. PREPARE SURFACES FOR NEW PAINT FINISH TO MATCH EXISTING, TYPICAL

ADD ALT #1: PROTECT IN PLACE EXISTING DOOR. REPLACE MISSING TRANSOM GLAZING PER HISTORIC ASSEMBLY

ADD ALT #1: PREPARE EXISTING DOOR TRIM SURFACES FOR NEW PAINT TO MATCH EXISTING

**REVISIONS:** 

EXTERIOR SOUTHEAST ENTRY DETAIL

SHEET NO: A101

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DATE: 5/24/22

CHECKED: DJD

PROJECT: 1718.65

DRAWING TITLE:

PHOTOS

DRAWN: JB

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EXTERIOR SOUTHWEST CORNER DETAIL

EXTERIOR SOUTH FACADE

ADD ALT #1: PROTECT IN PLACE EXISTING DOOR.
PREPARE SURFACE FOR NEW PAINT TO MATCH

ADD ALT #1: REMOVE EXISTING CEDAR SHAKE SIDING AND UNDERLAYMENT. EXISTING WALL SHEATHING TO REMAIN. REPAIR DAMAGED SHEATHING AS NECESSARY. REFER TO DETAILS FOR NEW SIDING, UNDERLAYMENT, AND FLASHING

ADD ALT #1: PROTECT IN PLACE EXISTING RAFTER TAILS AND SHEATHING. PREPARE SURFACES FOR NEW PAINT FINISH TO MATCH EXISTING, TYPICAL

ADD ALT #1: PREPARE **EXISTING SIDING PANELS** AND TRIM TO RECEIVE NEW PAINT TO MATCH EXISTING, TYPICAL

**ADD ALT #1:** REMOVE AND REINSTALL EXISTING GUTTERS AFTER PAINTING ACTIVITIES, INSTALL W/ POSITIVE DRAINAGE TO LEADER

ADD ALT #1: PREPARE EXISTING CANOPY SOFFIT, BEAMS, TRIM, COLUMN, CAP, AND BASE SURFACES FOR NEW PAINT TO MATCH EXISTING

**ADD ALT #1: PREPARE** EXISTING PANEL SIDING, TRIM AND SILL FOR NEW PAINT TO MATCH EXISTING. REPAIR DAMAGED PANELS AND TRIM AS NECESSARY



ALL EXISTING CEDAR SHAKE ROOF FINISH AND UNDERLAYMENT **EXISTING ROOF** SHEATHING TO REMAIN. INSPECT AND REPLACE DAMAGED SHEATHING AS NECESSARY

**ADD ALT #1:** REMOVE

**ADD ALT #1:** PREPARE


EXISTING KNEE BRACE

SURFACES FOR NEW

PAINT TO MATCH

EXISTING, TYPICAL

ADD ALT #1: REMOVE AND REPLACE TRIM OVER ROOF FLASHING. PROFILE AND FINISH TO MATCH EXISTING. PROVIDE SEALANT AS REQUIRED. COORDINATE WITH FLASHING AND NEW METAL ROOF ASSEMBLY. NEW WOOD TO MATCH EXISTING SPECIES.

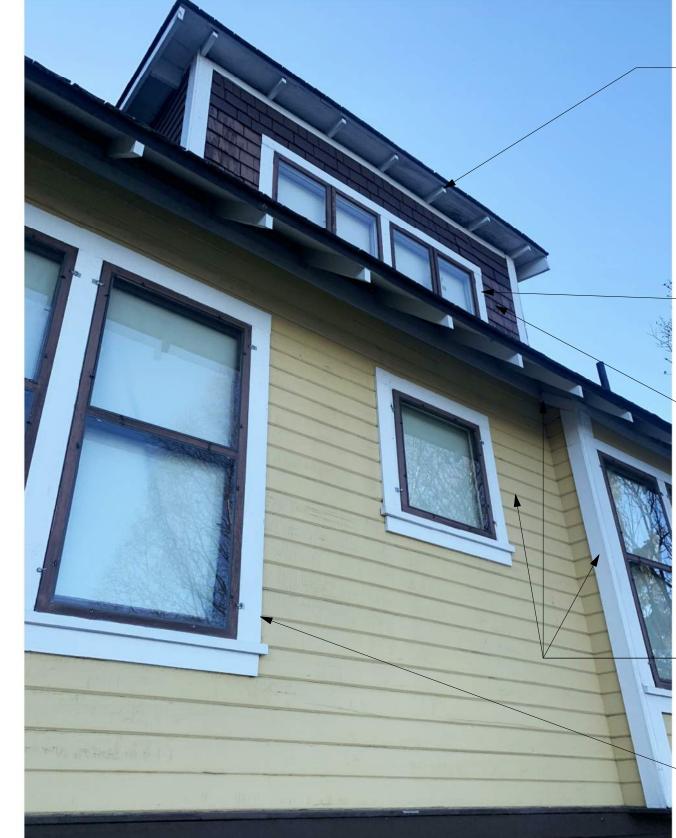

ADD ALT #1: PREPARE DORMER RAFTER TAILS, RAKE, AND SHEATHING SURFACES FOR NEW PAINT TO MATCH EXISTING

DAVE JAMES DREHER

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REPLACEMER REFURBISH A20 M ST, ANCHORA

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DATE: 5/24/22

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PROJECT: 1718.65

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ADD ALT #1: CAREFULLY REMOVE (E) DORMER WALL WINDOW TRIM, STORE, AND PREPARE SURFACES FOR NEW PAINT TO MATCH EXISTING REMOVE DORMER WALL CEDAR SHAKE FINISH,

UNDERLAYMENT, FLASHING, AND TRIM (E) WALL SHEATHING TO REMAIN, INSPECT FOR DAMAGE AND REPLACE IN KIND AS REQUIRED. REPLACE ALL IN KIND TO MATCH


**ADD ALT #1: PREPARE EXISTING SIDING PANELS** AND TRIM TO RECEIVE NEW PAINT TO MATCH EXISTING, TYPICAL

**ADD ALT #1: PREPARE EXISTING WINDOW TRIM** AND SASH SURFACES FOR NEW PAINT TO MATCH EXISTING, TYPICAL

EXTERIOR WEST FACADE DORMER DETAILS

EXTERIOR NORTHWEST CORNER DETAIL

1/8" = 1'-0"

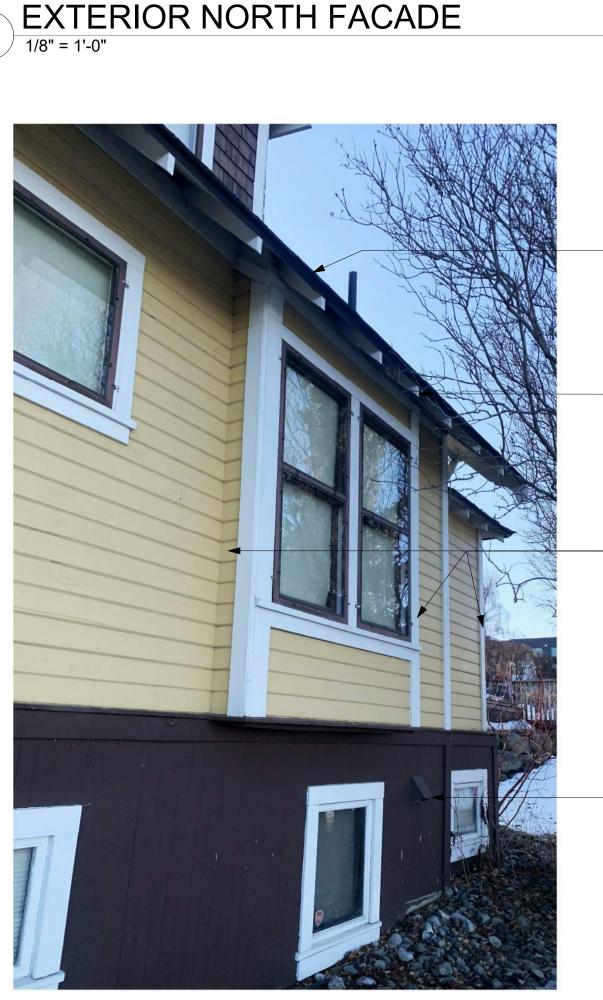

REMOVE EXISTING EAVE FLASHING AND REFER TO DETAILS FOR NEW FINISHES AND ASSEMBLY, **TYPICAL** 

**ADD ALT #1: PROTECT IN** PLACE EXISTING RAFTER TAILS AND SHEATHING. PREPARE SURFACES FOR NEW PAINT FINISH TO MATCH EXISTING, TYPICAL

**ADD ALT #1:** PREPARE **EXISTING SIDING PANELS** AND TRIM TO RECEIVE NEW PAINT TO MATCH EXISTING, TYPICAL

ADD ALT #1: PREPARE EXISTING VENT HOOD SURFACES FOR NEW PAINT TO MATCH **EXISTING, TYPICAL** 

REMOVE ALL EXISTING DORMER CEDAR SHAKE **ROOF FINISH AND** EXISTING ROOF SHEATHING TO REMAIN.
INSPECT AND REPLACE
DAMAGED SHEATHING AS NECESSARY

REMOVE EXISTING DORMER BASE FLASHING AND REPLACE IN COORDINATION WITH NEW METAL ROOF ASSEMBLY

REMOVE ALL EXISTING CEDAR SHAKE ROOF FINISH AND UNDERLAYMENT **EXISTING ROOF** SHEATHING TO REMAIN. INSPECT AND REPLACE DAMAGED SHEATHING AS NECESSARY

ADD ALT #1: PREPARE — EXISTING WINDOW TRIM AND SASH SURFACES FOR NEW PAINT TO MATCH EXISTING, TYPICAL

PANEL SIDING, TRIM AND SILL FOR NEW PAINT TO MATCH EXISTING, TYPICAL REPAIR DAMAGED PANELS AND TRIM AS NECESSARY



PROTECT EXISTING CHIMNEY IN PLACE.
PROVIDE NEW FLASHING
IN COORDINATION WITH NEW METAL ROOF ASSEMBLY

PROTECT EXISTING PLUMBING VENT IN PLACE. REPLACE FLASHING IN COORDINATION WITH NEW METAL ROOF ASSEMBLY, TYPICAL

ADD ALT #1 NOTE: MAINTAIN EXISTING TRIM TO THE GREATEST EXTENT POSSIBLE. REPAIRS USING FILLING AND SMOOTHING COMPOUNDS IS ACCEPTABLE. IF WOOD REPLACEMENT IS REQUIRED, REPLACE WITH THE SAME WOOD SPECIES AS THE EXISTING

> ADD ALT #1: PREPARE EXISTING SIDING PANELS AND TRIM TO RECEIVE NEW PAINT TO MATCH EXISTING, TYPICAL

ADD ALT #1: PREPARE EXISTING WINDOW TRIM AND SASH SURFACES FOR NEW PAINT TO MATCH EXISTING, TYPICAL. REPAIR DAMAGED SILL AND TRIM AS NECESSARY DRAWING

**REVISIONS:** 

PHOTOS

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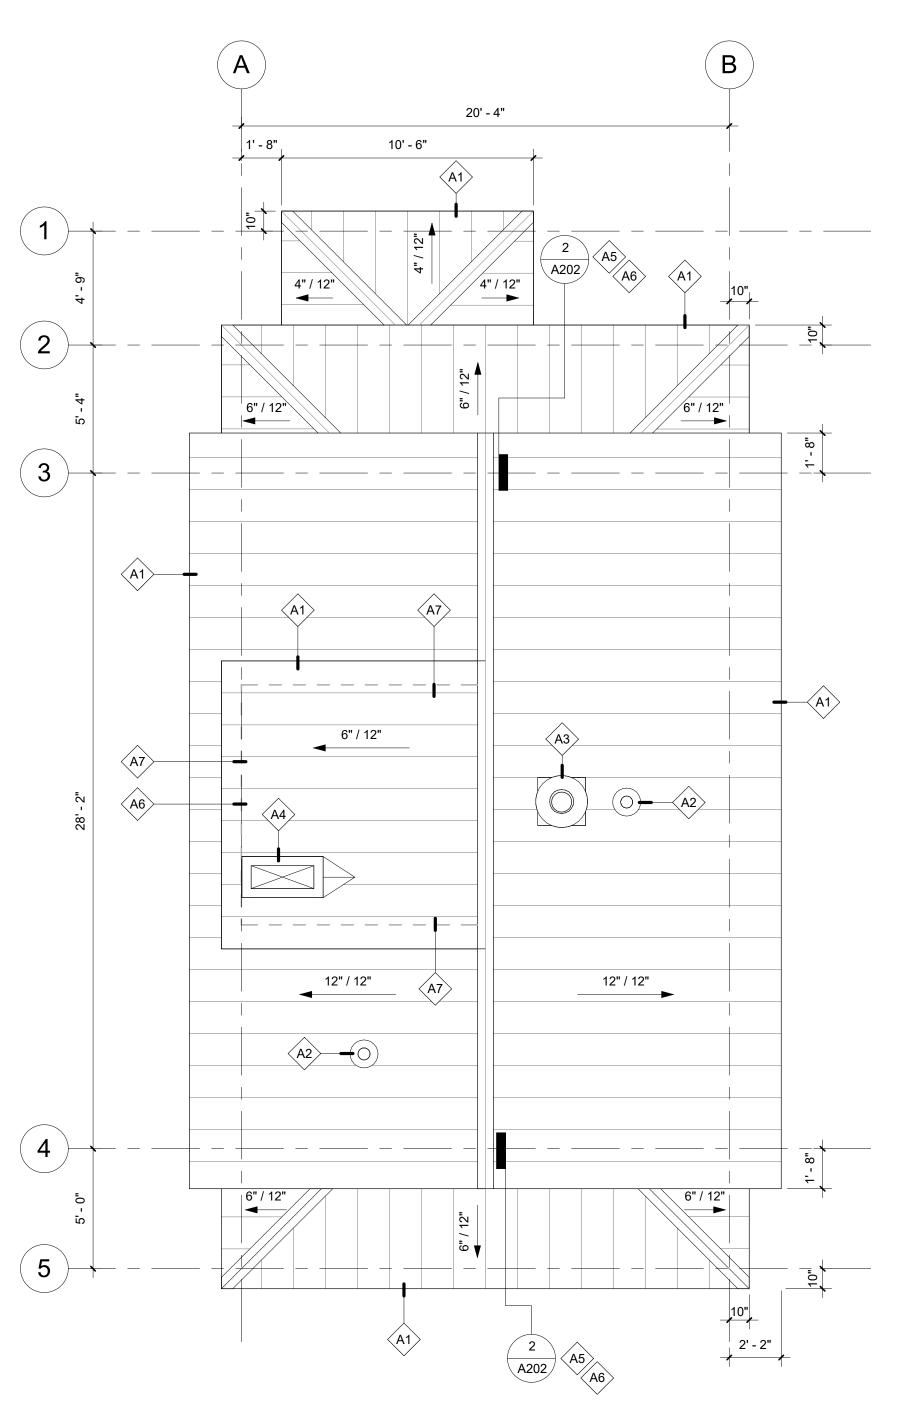
A102

EXTERIOR WEST FACADE DETAILS

1/8" = 1'-0"

EXTERIOR WEST FACADE


1/8" = 1'-0"





## **ARCHITECTURAL KEY NOTES**

- A1 (N) ROOF ASSEMBLY
- A2 (N) FLASHING @ (E) VTR
- A3 (N) FLASHING @ (E) MECHANICAL FLUE
- A4 (N) BASE AND TAPERED CRICKET AT (E) BRICK FLUE
- (N) ICE BARRIER UNDERLAYMENT AND CEDAR SHAKE SIDING TO MATCH
- EXISTING AT GABLE WALL. REFER ALSO TO DETAILS
- A6 REINSTALL (E) WINDOW TRIM AND PAINT TO MATCH EXISTING. PREPARE SURFACE OF (E) WINDOW FRAME AND SASH TO RECEIVE PAINT TO MATCH
- A7 (N) ICE BARRIER, BASE FLASHING, AND CEDAR SHAKE SIDING TO MATCH EXISTING AT DORMER WALLS.

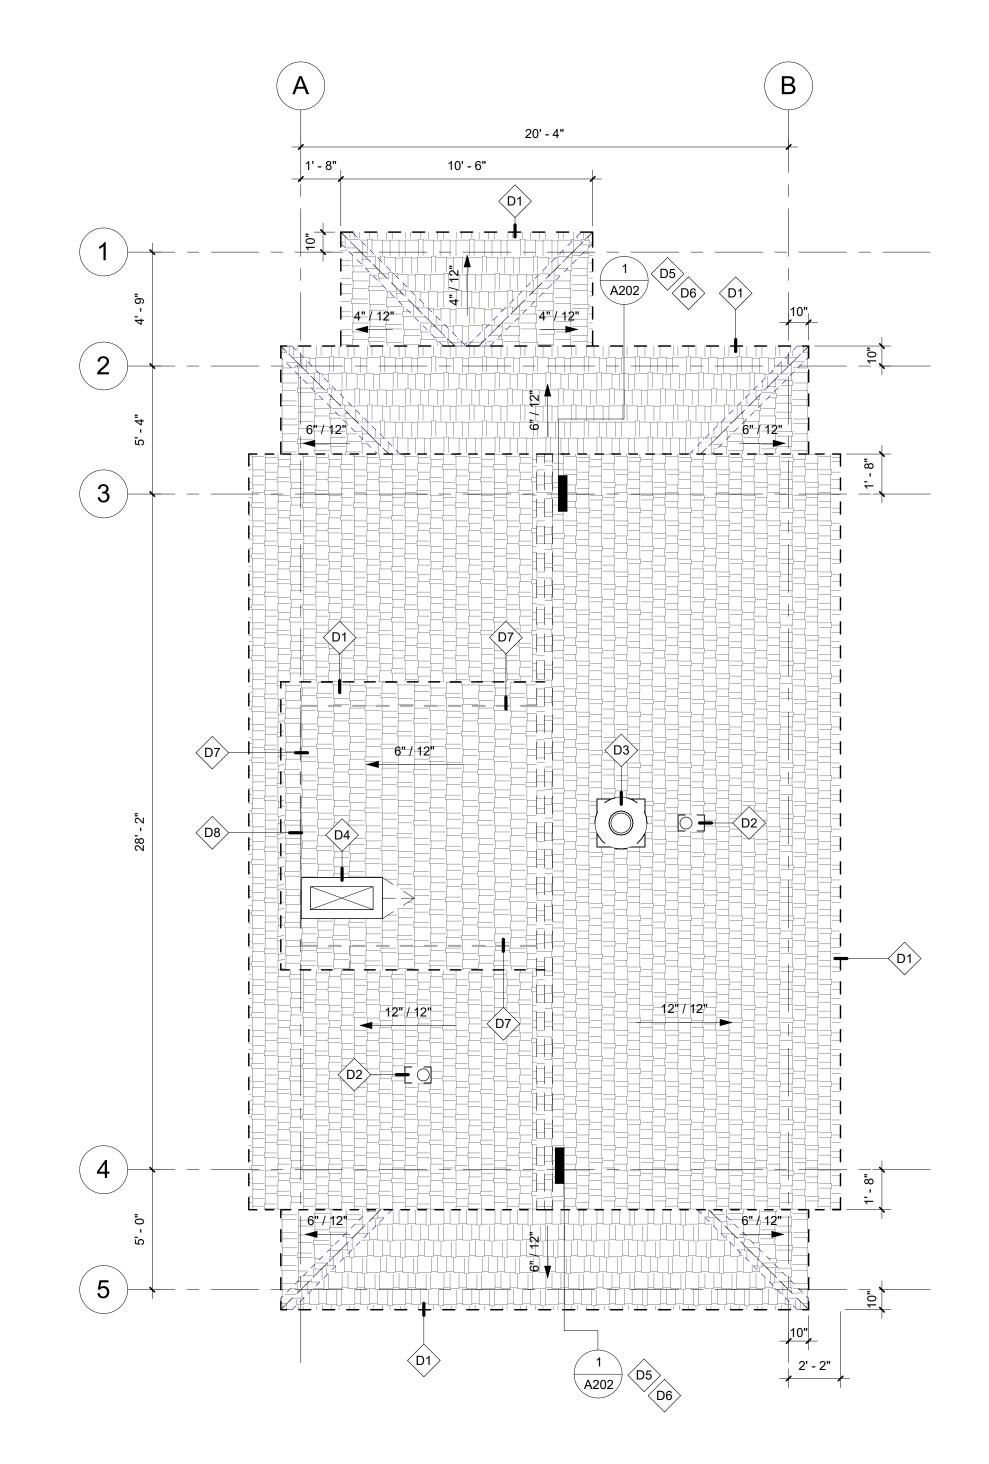

## ROOF DEMOLITION PLAN

## **DEMOLITION KEY NOTES**

- D1 REMOVE CEDAR SHAKE ROOF FINISH AND UNDERLAYMENT. EXISTING SHEATHING TO REMAIN. INSPECT FOR DAMAGE AND REPLACE IN KIND AS REQUIRED
- D2 VTR TO REMAIN. REMOVE EXISTING BASE FLASHING
- D3 MECHANICAL FLUE TO REMAIN. REMOVE EXISTING BASE FLASHING
- D4 EXISTING BRICK FLUE AND FLASHING CAP TO REMAIN, PROTECT IN PLACE. REMOVE (E) BASE AND CRICKET FLASHING
- D5 REMOVE GABLE WALL CEDAR SHAKE FINISH AND UNDERLAYMENT
- D6 CAREFULLY REMOVE EXISTING GABLE WALL WINDOW TRIM, STORE, AND PREPARE SURFACES FOR NEW PAINT TO MATCH EXISTING
- D7 REMOVE DORMER WALL CEDAR SHAKE FINISH, UNDERLAYMENT, FLASHING, AND TRIM. (E) WALL SHEATHING TO REMAIN, INSPECT FOR DAMAGE AND REPLACE IN KIND AS REQUIRED
- D8 CAREFULLY REMOVE (E) DORMER WALL WINDOW TRIM, STORE, AND PREPARE SURFACES FOR NEW PAINT TO MATCH EXISTING



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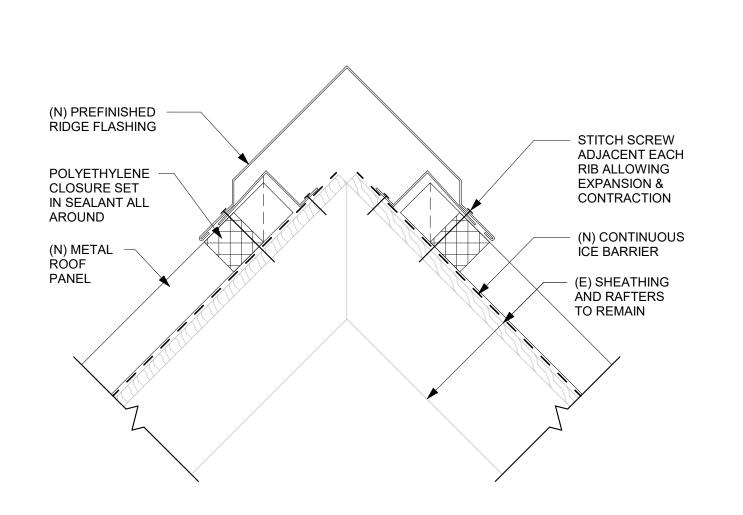
PROJECT: 1718.65

DRAWING TITLE: ROOF PLANS - DEMO & NEW


**REVISIONS:** 

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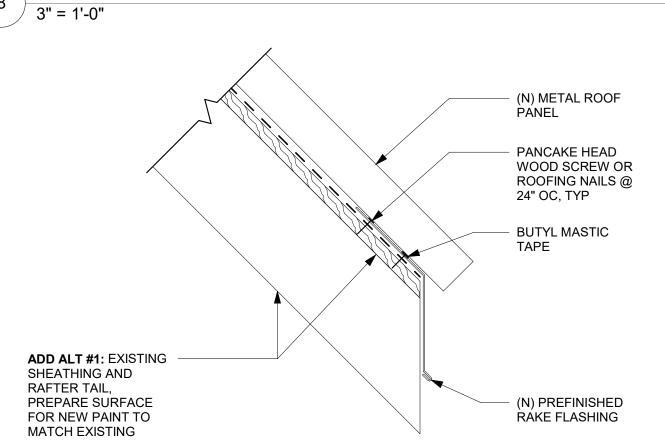
A103




## 9 DETAIL - TYPICAL RIDGE FLASHING 9 3" = 1'-0"

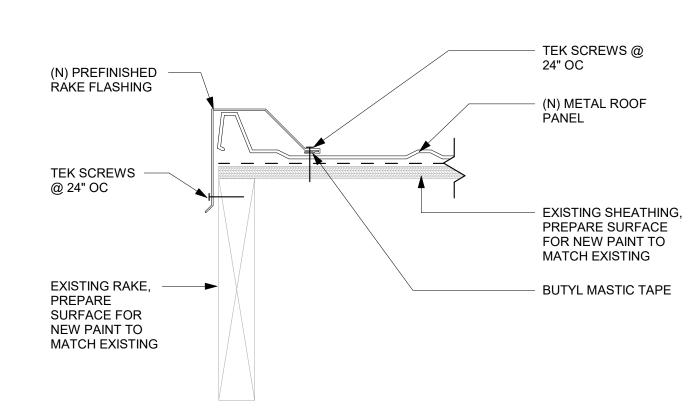

8 DETAIL - TYPICAL RAKE
3" = 1'-0"




DETAIL - TYP. EAVE FLASHING
3" = 1'-0"

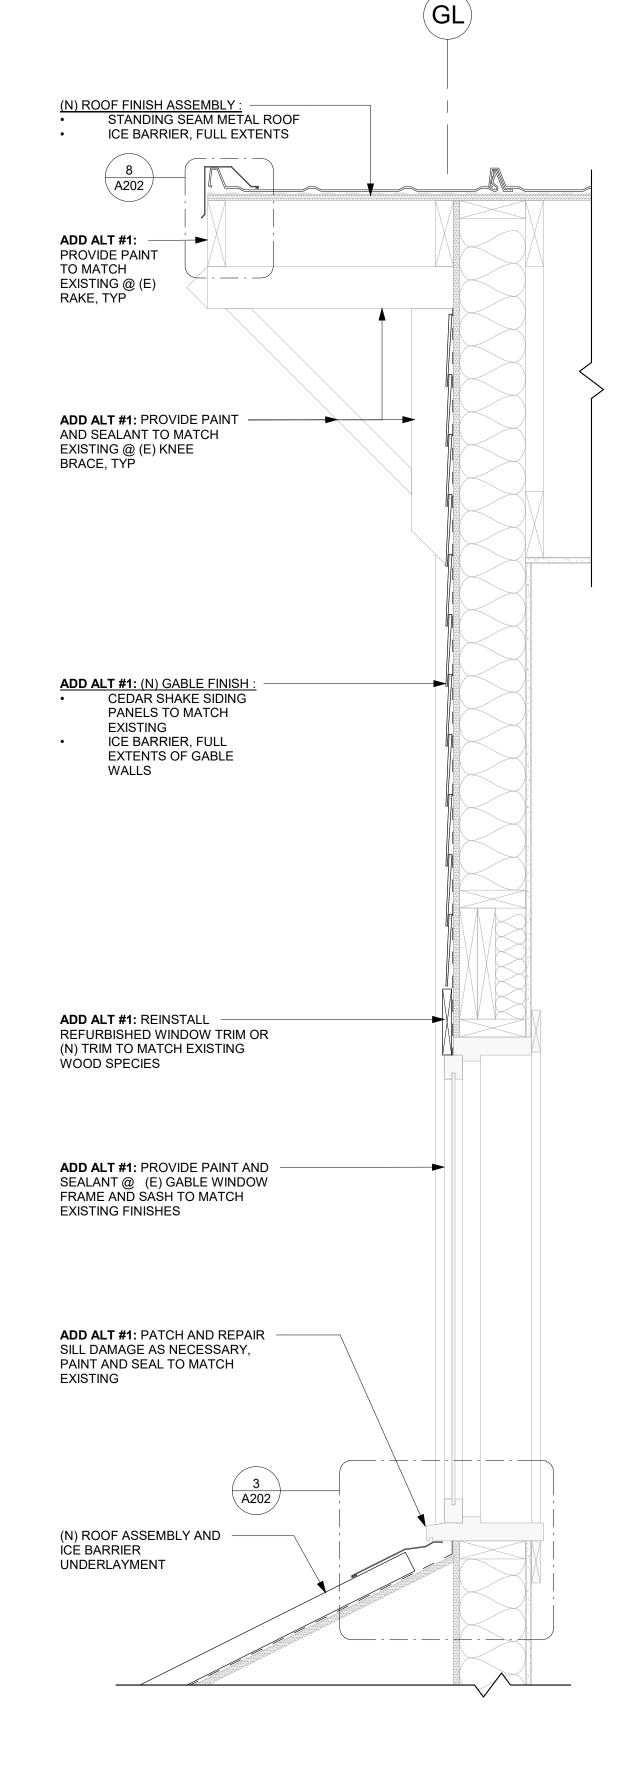

DETAIL - GABLE (N) FINISHES


1 1/2" = 1'-0"

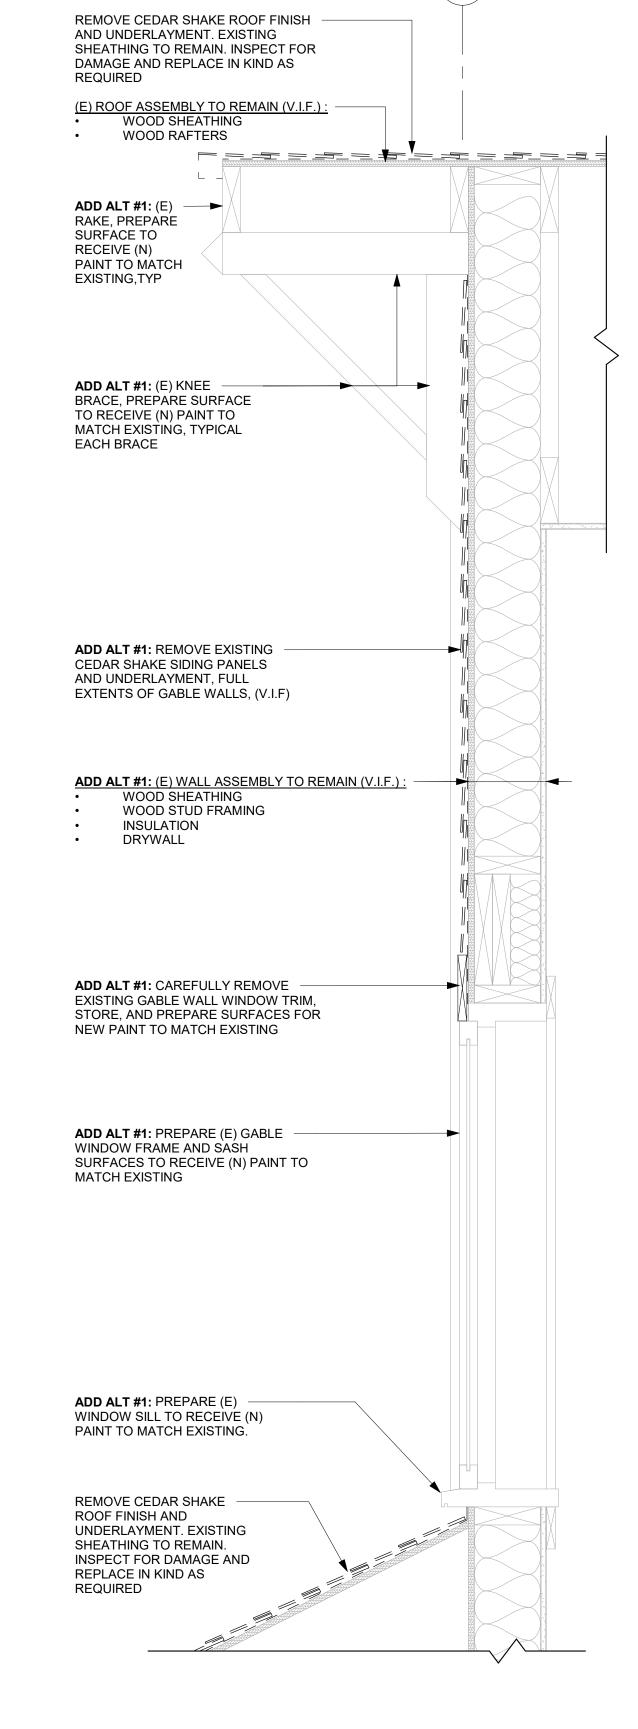


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DETAIL - GABLE FINISH DEMO

ADD ALT #1 NOTE: MAINTAIN EXISTING TRIM TO THE GREATEST EXTENT POSSIBLE. REPAIRS USING FILLING AND SMOOTHING COMPOUNDS IS ACCEPTABLE. IF WOOD REPLACEMENT IS REQUIRED, REPLACE WITH THE SAME WOOD SPECIES AS THE EXISTING

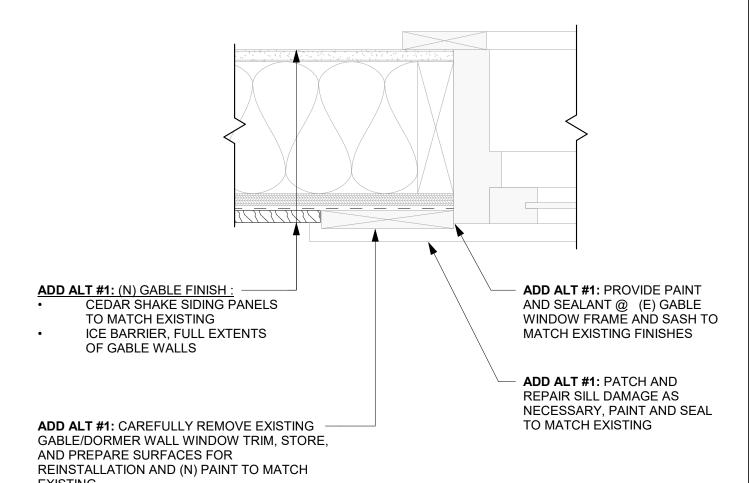

DETAIL - TYP. WINDOW JAMB

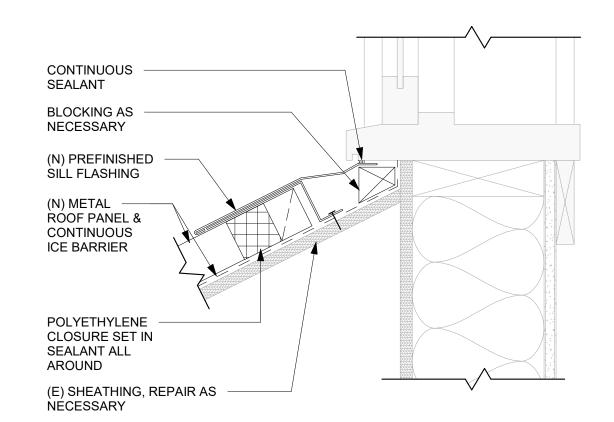

DETAIL - SILL FLASHING

3" = 1'-0"

OSCAR ANDERSON HOUSE MUSEUM
ROOF REPLACEMENT & EXTERIOR
REFURBISHMENT
420 M ST, ANCHORAGE, ALASKA

DAVE JAMES DREHER

DATE: 5/24/22
DRAWN: JB

CHECKED: DJD

PROJECT: 1718.65
DRAWING TITLE:

ROOF DETAILS -DEMO & NEW

REVISIONS:

SHEET NO:

A202